


INDEX OF SHEETS

- SHEET NO. 1 TITLE
- SHEET NO. 2 TYPICAL CROSS SECTIONS
- SHEET NO. 2 ESTIMATE OF QUANTITIES
- SHEET NO. 2 MISCELLANEOUS QUANTITIES
- SHEET NO. - RIGHT OF WAY PLAT
- SHEET NO. 3-10 PLAN AND PROFILE STA. TO STA.
- SHEET NO. 11-14 STANDARD DETAILS
- SHEET NO. - DRAINAGE STRUCTURES
- SHEET NO. 15-36 CROSS SECTIONS

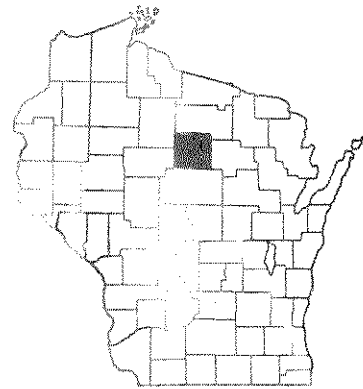


STATE OF WISCONSIN
STATE HIGHWAY COMMISSION OF WISCONSIN

PLAN AND PROFILE OF PROPOSED
C.T.H. "W" - C.T.H. "X" ROAD
C.T.H. "P"
LINCOLN COUNTY
PROJECT S 0569(4)

COUNTY AND HIGHWAY	ROUTE AND SECTION	CLASS AND AGREEMENT		FEDERAL DIVISION OFFICE	SHEET NUMBER	TOTAL SHEETS
		STATE	FEDERAL			
35.6	569.0		11.4	WIS. 5N	1	36

PLAN 1 IN. = 100 FT.
PROFILE HOR. 1 IN. = 100 FT. VERT. 1 IN. = 10 FT.
CROSS SECTIONS HOR. 1 IN. = 5 FT. VERT. 1 IN. = 5 FT.

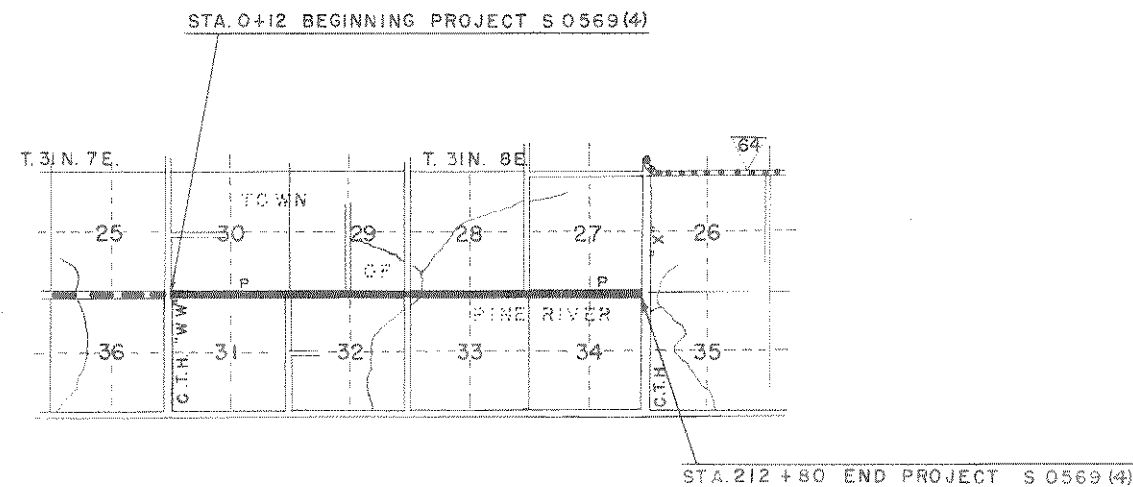

CONVENTIONAL SIGNS


- | | |
|--------------------------------|---------------------------------------|
| STATE LINE..... | CULVERTS IN PLACE..... |
| COUNTY LINE..... | CULVERTS REQUIRED..... |
| TOWNSHIP OR RANGE LINE..... | DROP INLET..... |
| SECTION LINE..... | POWER POLE..... |
| NEW RIGHT OF WAY LINE..... | TELEPHONE OR TELEGRAPH POLE..... |
| PRESENT RIGHT OF WAY LINE..... | RIGHT OF WAY MARKERS..... |
| WIRE FENCE {WOVEN..... | REFERENCE STAKE FOR HUBS ONLY..... |
| {BARBED..... | MARSH..... |
| LOT LINE..... | HEDGE..... |
| CORPORATE OR CITY LIMITS..... | TREES..... |
| PROPERTY LINE..... | GROUND ELEVATION..... DATUM LINE..... |
| TRAVELED WAY OR I.P.E..... | GRADE ELEVATION..... DATUM LINE..... |
| RAILROADS..... | |
| BASE OR SURVEY LINE..... | |

LAYOUT

SCALE 0 1/2 1
TOTAL NET LENGTH OF CENTERLINE = 4.028 MILES


STATE HIGHWAY COMMISSION OF WISCONSIN MADISON, WIS.		DEPARTMENT OF COMMERCE BUREAU OF PUBLIC ROADS	
DESIGNED BY: C.E.H.A.R.M.B. NOTE BOOK 8400 CHECKED BY: W.D. M.D. CHECKER DATE: 7/13/53		RECOMMENDED FOR APPROVAL:	
CORRECTED BY: <i>E. C. Rostetter</i> DATE: 7/13/53		DISTRICT ENGINEER DATE	
APPROVED BY: <i>E. C. Rostetter</i> DATE: 7/13/53		APPROVED:	
STATE HIGHWAY ENGINEER		DIVISION ENGINEER DATE	

BPR DIVISION	PROJECT	SHEET NUMBER	TOTAL SHEETS
5 N	S 0569(4)	3	36

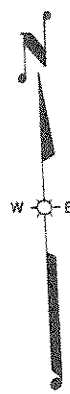

STA 0+00 ENTRANCE LT.
REMOVE 1-18" X 32' C.G.S.M. PIPE CULVERT
1-24" X 34' PIPE CULV. REQD.

STA 0+00 C.T.H. RT.
1-24" X 40 PIPE CULV IN PLACE
TO REMAIN

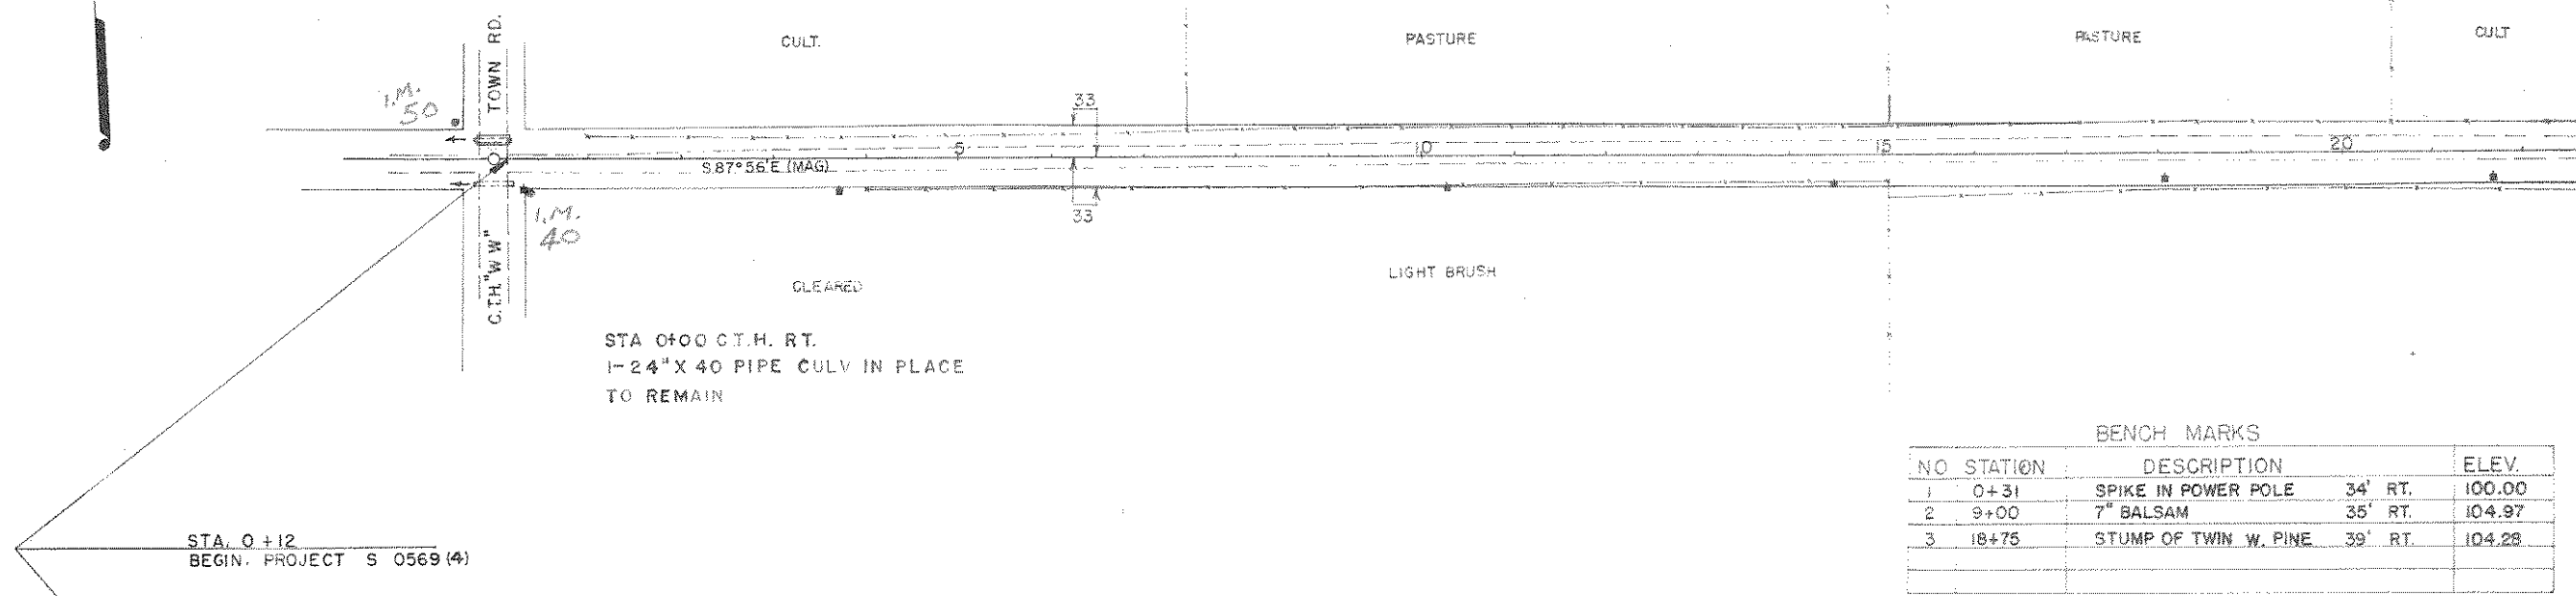


BENCH MARKS

NO	STATION	DESCRIPTION	ELEV.
1	0+31	SPIKE IN POWER POLE 34' RT.	100.00
2	9+00	7" BALSAM 35' RT.	104.97
3	18+75	STUMP OF TWIN W. PINE 39' RT.	104.28

STA. 0+12
BEGIN. PROJECT S 0569 (4)

NET CENTERLINE LENGTH STA. 0+12 TO STA. 20+00 = 1988 LIN. FT.

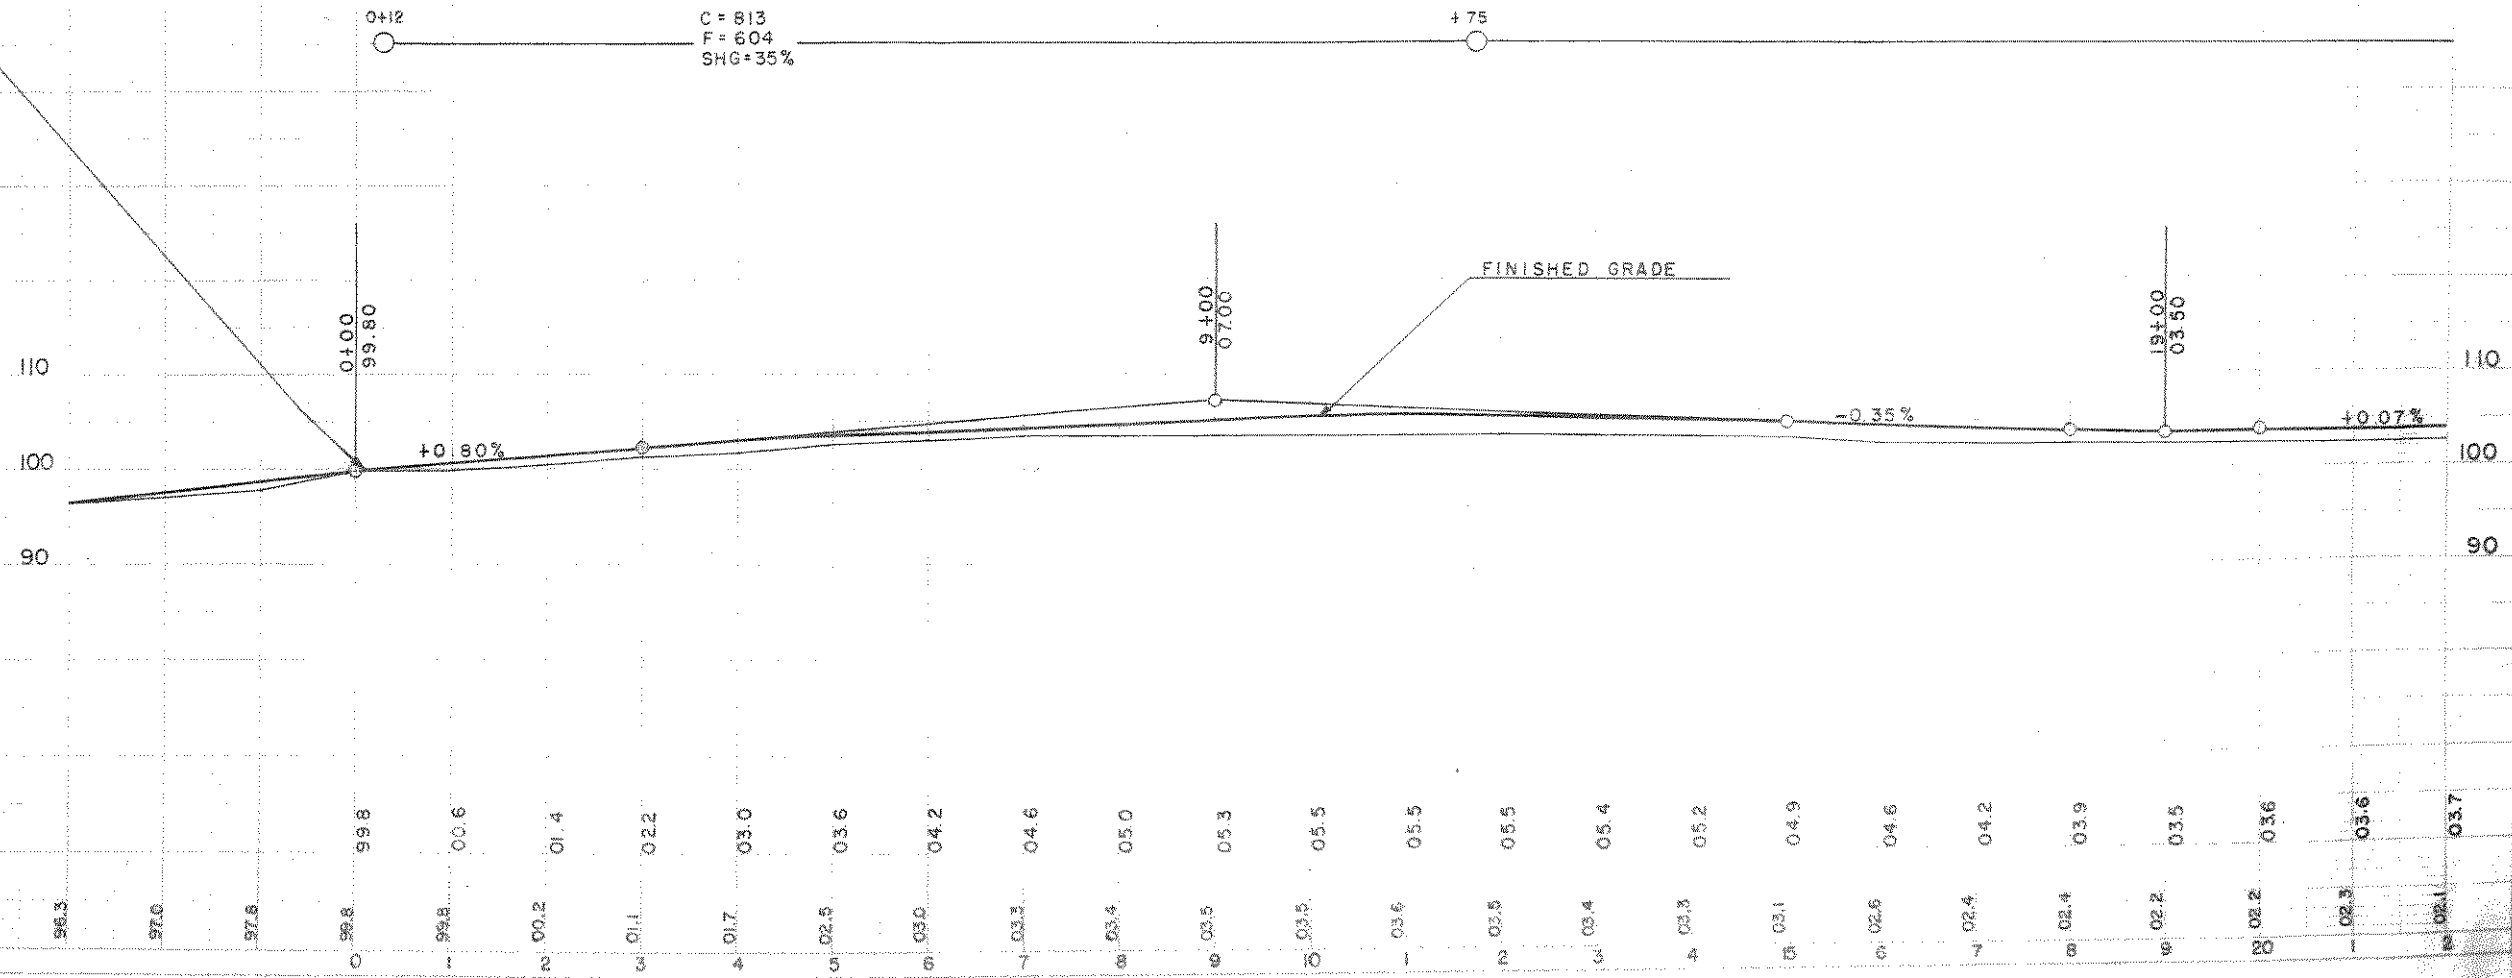


PLAN
DATE: 11/22/00
SCALE: 1" = 40'

PROFILE
DATE: 11/22/00
SCALE: 1" = 40'

BPR DIVISION	PROJECT	SHEET TOTAL	
S N	S 0569(4)	4	36


PLAN
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 DRAWN BY: [Signature]
 CHECKED BY: [Signature]
 SCALE: AS SHOWN

PROFILE
 DATE: 8/22/82
 DRAWN BY: [Signature]
 CHECKED BY: [Signature]
 SCALE: AS SHOWN

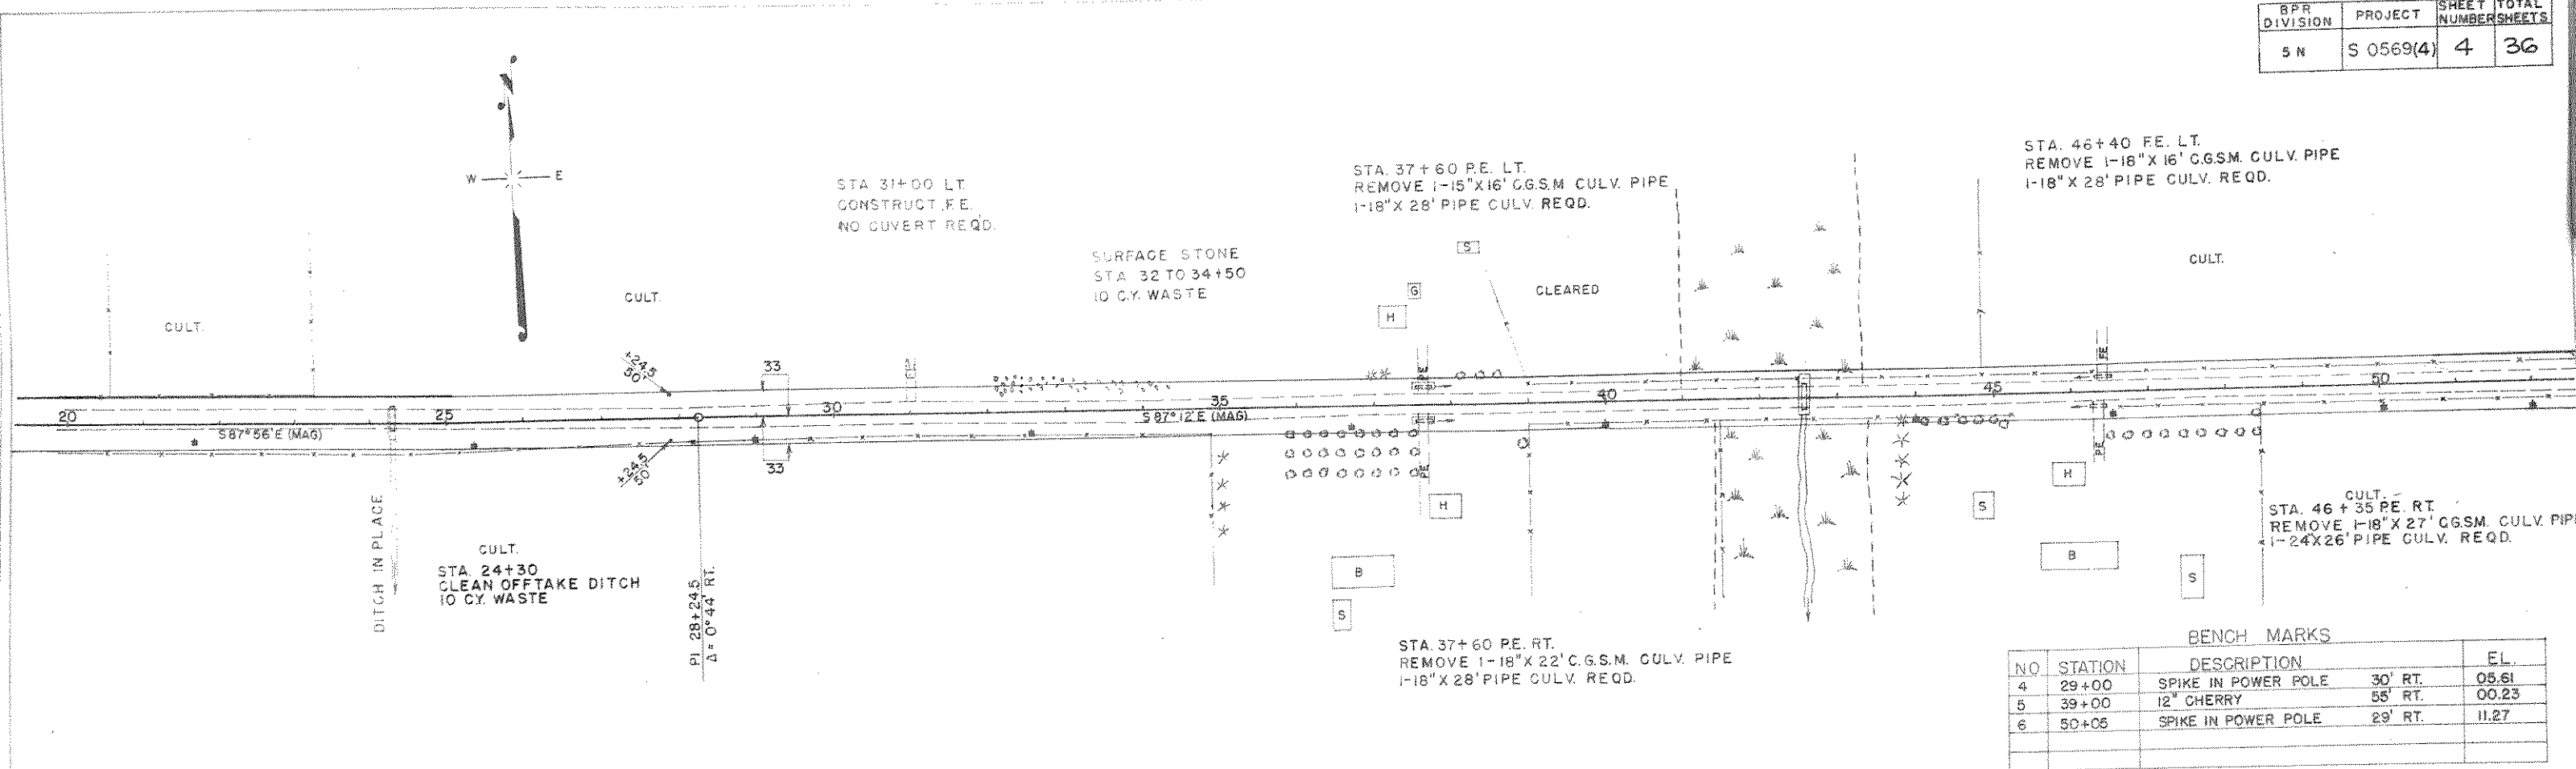


BENCH MARKS

NO	STATION	DESCRIPTION	30' RT.	EL.
4	29+00	SPIKE IN POWER POLE	30' RT.	05.61
5	39+00	12" CHERRY	55' RT.	00.23
6	50+05	SPIKE IN POWER POLE	29' RT.	11.27

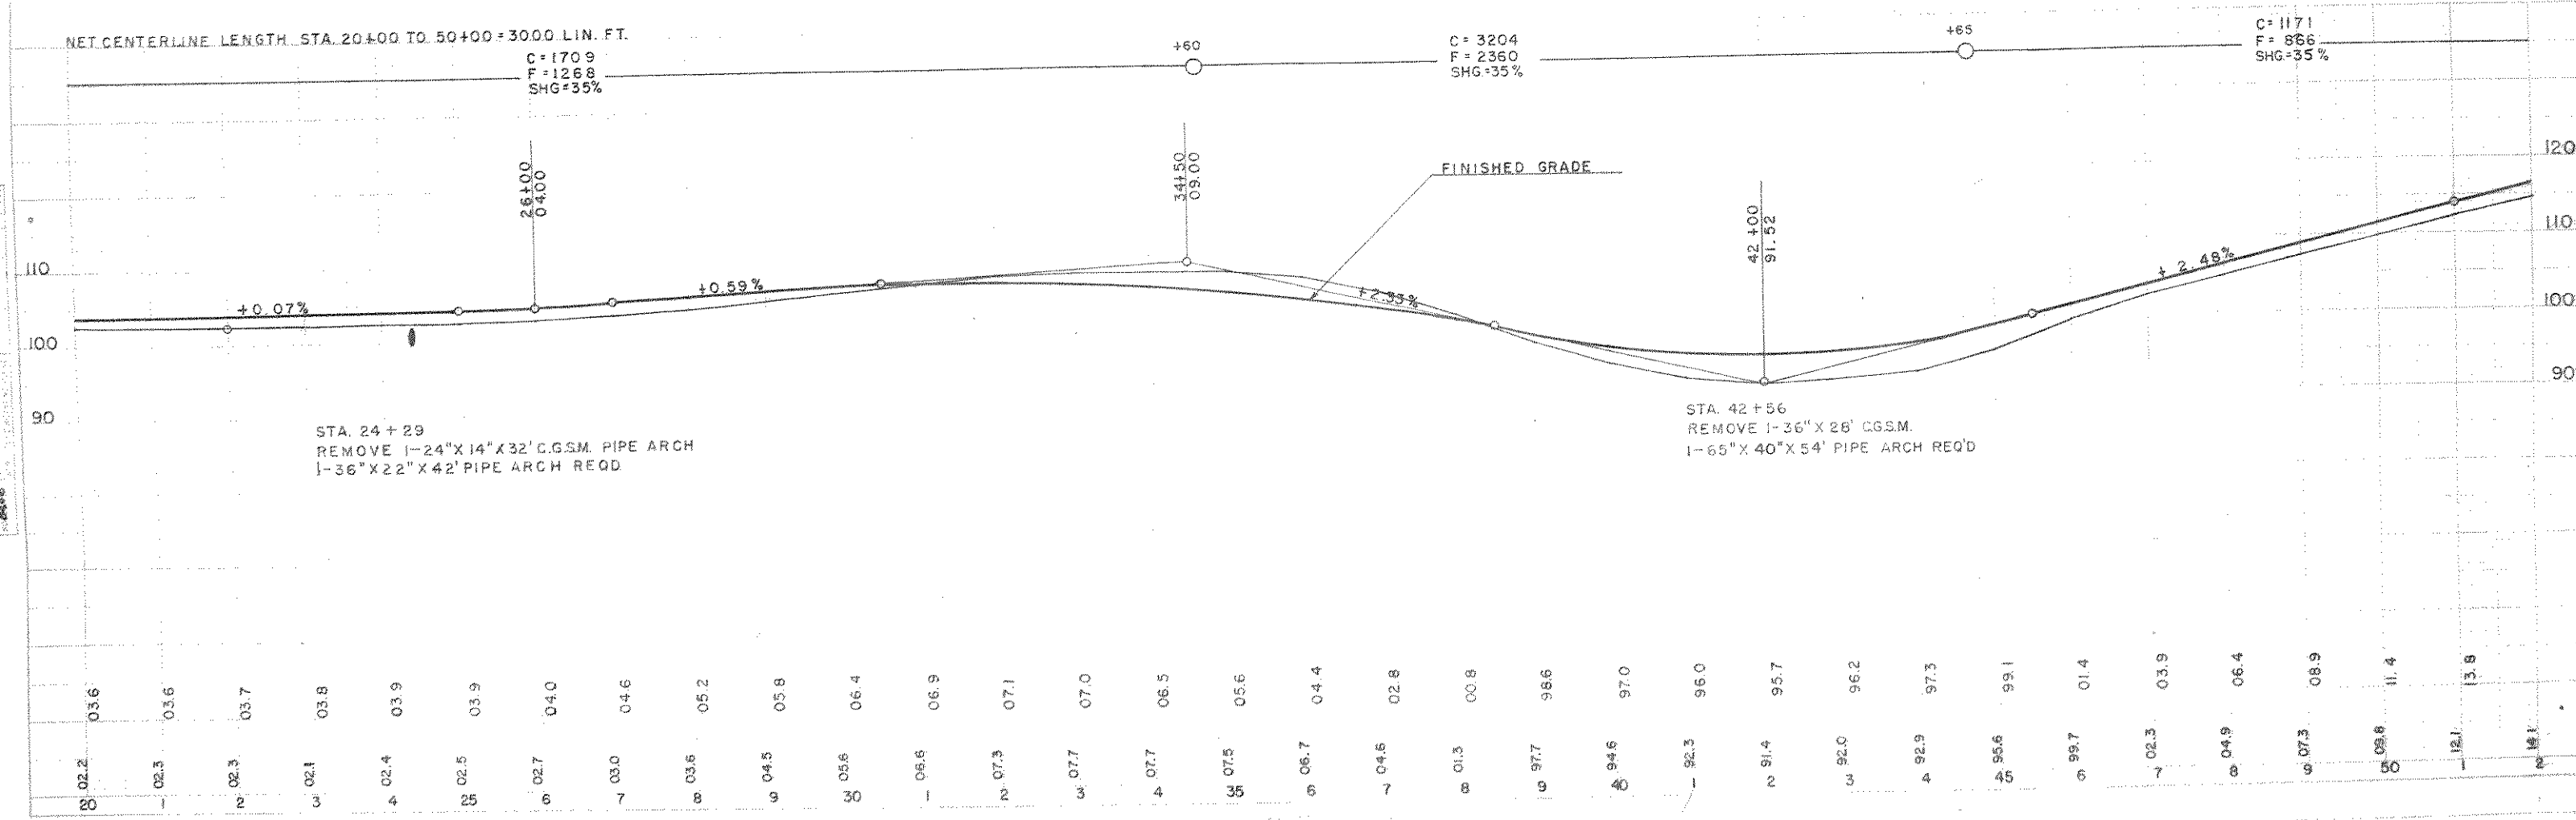

BPR DIVISION	PROJECT	SHEET NUMBER	TOTAL SHEETS
5 N	S 0569(4)	5	36

STA. 54+75 ENT. LT.
1-18"X34' PIPE CULV. REQD.

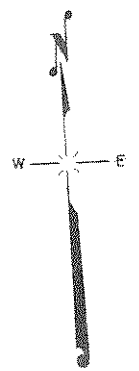

STA. 57+45 PE. LT.
REMOVE 1-15"X16' CGSM. PIPE CULV.
1-18"X28' PIPE CULV. REQD.

STA. 72+75 PE. LT.
REMOVE 1-18"X16' CGSM. PIPE CULV.
1-18"X28' PIPE CULV. REQD.

CULT.

CULT.

CULT.

CULT.

STA. 64+60 PE. RT.
REMOVE 1-15"X16' CGSM. PIPE CULV.
1-18"X28' PIPE CULV. REQD.

STA. 75+85 PE. RT.
REMOVE 1-15"X18' CGSM. PIPE CULV.
1-18"X28' PIPE CULV. REQD.

STA. 72+00
CLEAN OFF TAKE DITCH
10 C.Y. WASTE

SURFACE STONE
5 C.Y. PER STA 68-76
15 C.Y. PER STA 75-80


BENCH MARKS

NO	STATION	DESCRIPTION		EL.
6	50+05	SPIKE IN POWER POLE	29' RT.	11.27
7	61+47	"	27' RT.	29.26
8	70+15	8" MAPLE	40' LT.	40.12
9	79+35	14" HEMLOCK	45' LT.	30.16

NET CENTERLINE LENGTH STA. 50+00 TO STA. 80+00 = 3000 LIN. FT.

C = 890
T = 665
SHG = 35%

C = 3645
F = 2729
SHG = 35%

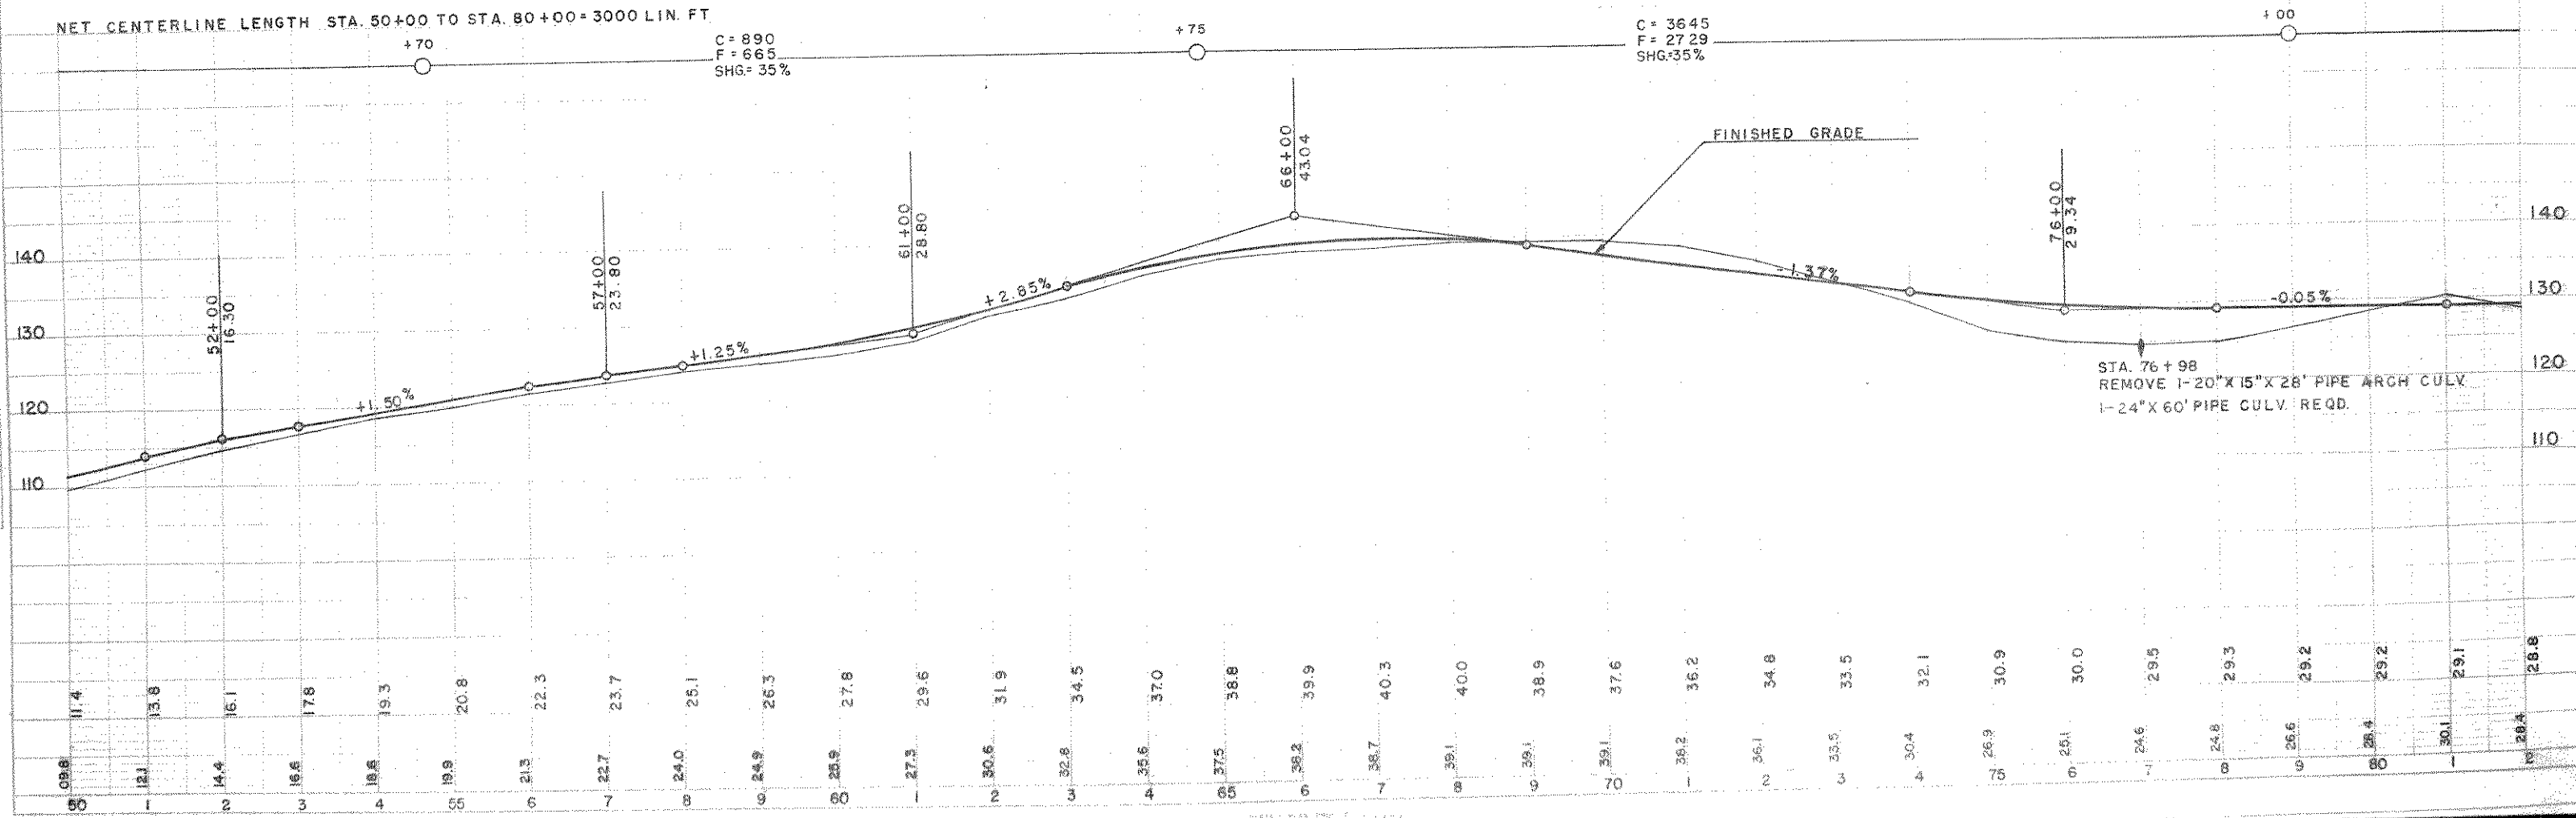


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BY: [Signature]
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SCALE: 1"=40'

DATE: 5-12-54
BY: [Signature]
CHECKED: [Signature]
SCALE: 1"=40'


STA. 114 + 30 FE. LT.
REMOVE 1-18" X 22' CGSM. PIPE CULV.
1-18" X 28' PIPE CULV. REQD.

STA. 122 + 00 FE. LT.
REMOVE 1-15" X 20' CGSM. PIPE
1-18" X 28' PIPE CULV. REQD.

STA. 139 + 49 FE. LT.
REMOVE 1-15" X 16' CGSM. PIPE CULV.
NO CULV. REQD.

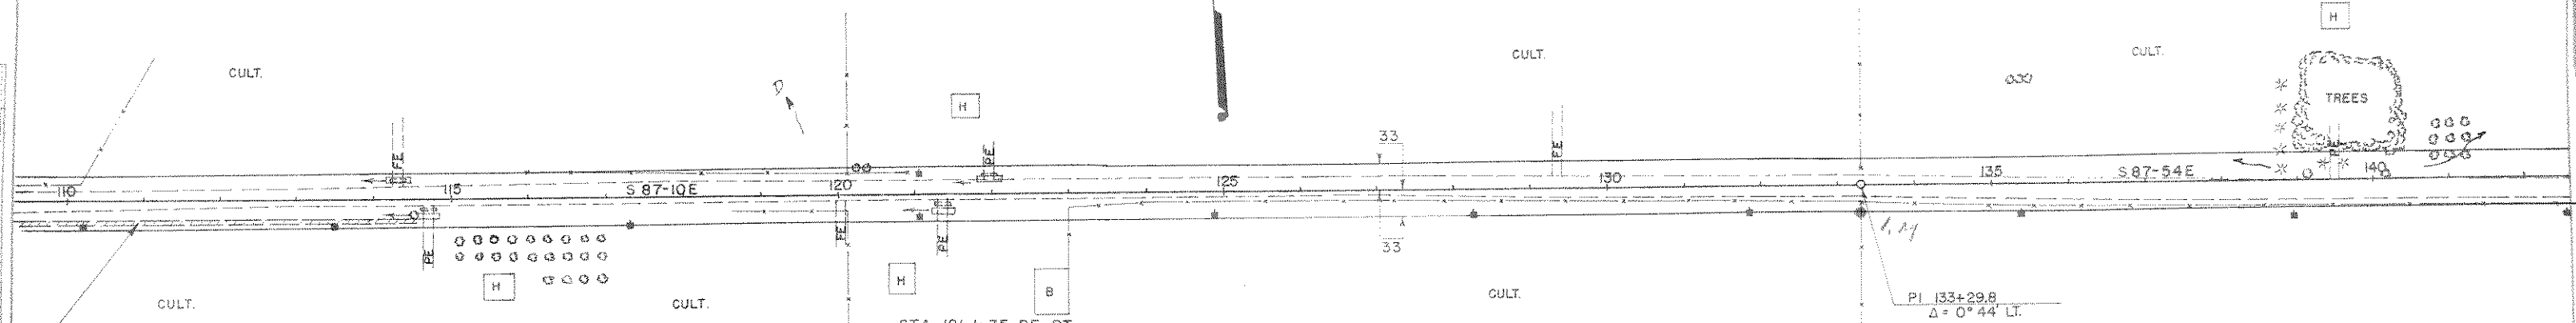

STA. 109+50 TO 114+70
CONSTRUCT INTERCEPTING EMBANKMENT
TO FORCE WATER TO CULVERT OFFTAKE

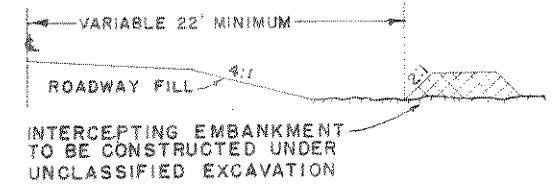


STA. 114 + 70 FE. RT.
REMOVE 1-18" X 22' CGSM. PIPE CULV.
1-24" X 26' PIPE CULV. REQD.

STA. 121 + 35 FE. RT.
REMOVE 1-18" X 22' CGSM. PIPE CULV.
1-24" X 26' PIPE REQD.

BENCH MARKS				
NO	STATION	DESCRIPTION		EL.
13	115+50	10" ELM	40' RT.	60.88
14	121+25	12" PINE	70' RT.	92.44
15	133+70	8" ELM	45' RT.	23.95


NET CENTERLINE LENGTH STA. 110+00 TO STA. 140+00 = 3000 LIN. FT.

C = 5814
F = 4396
SHG = 30%

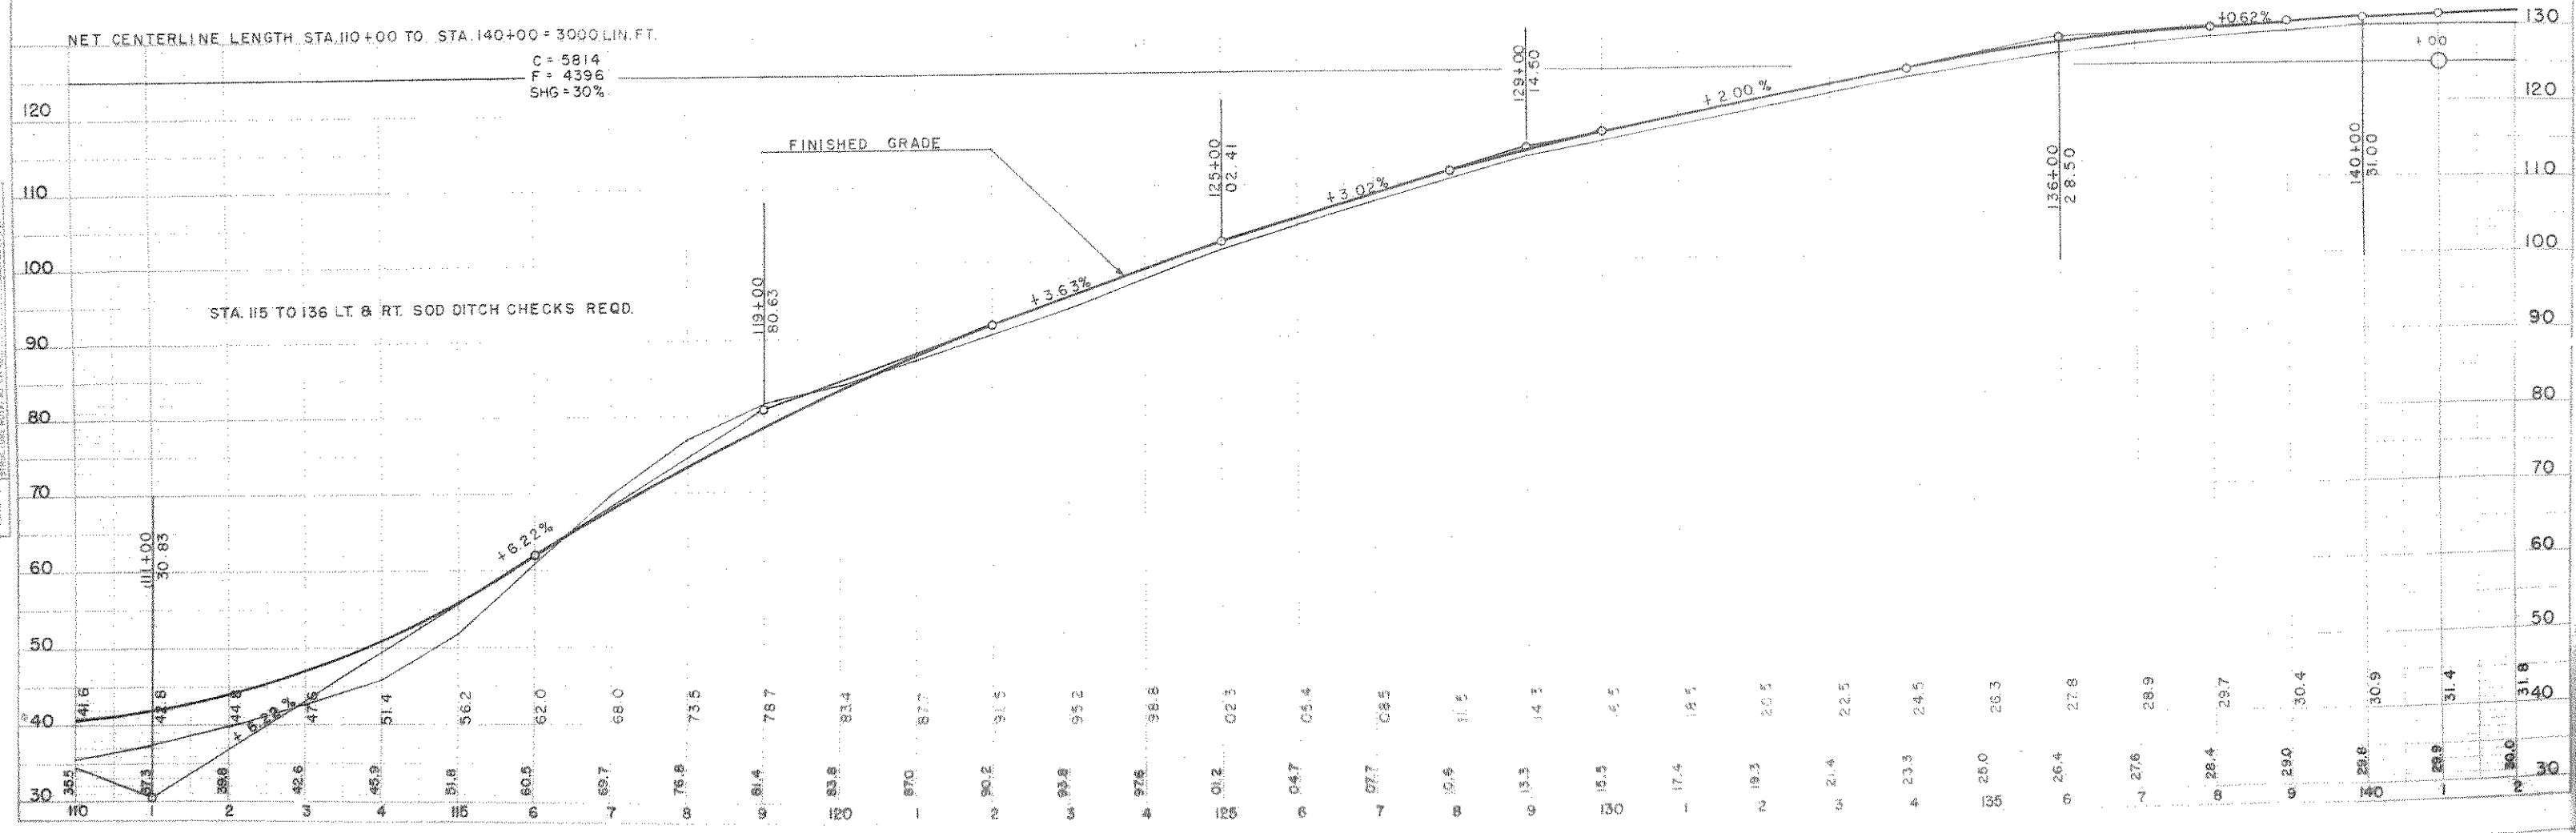


PLAN
DATE: 12-1-53
BY: [Signature]
CHECKED: [Signature]
SCALE: AS SHOWN

PROFILE
DATE: 12-1-53
BY: [Signature]
CHECKED: [Signature]
SCALE: AS SHOWN

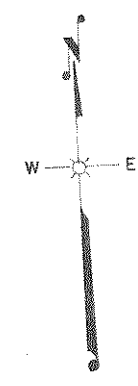


PLAN
 DRAWN BY: [Signature]
 CHECKED BY: [Signature]
 DATE: 5-2-53

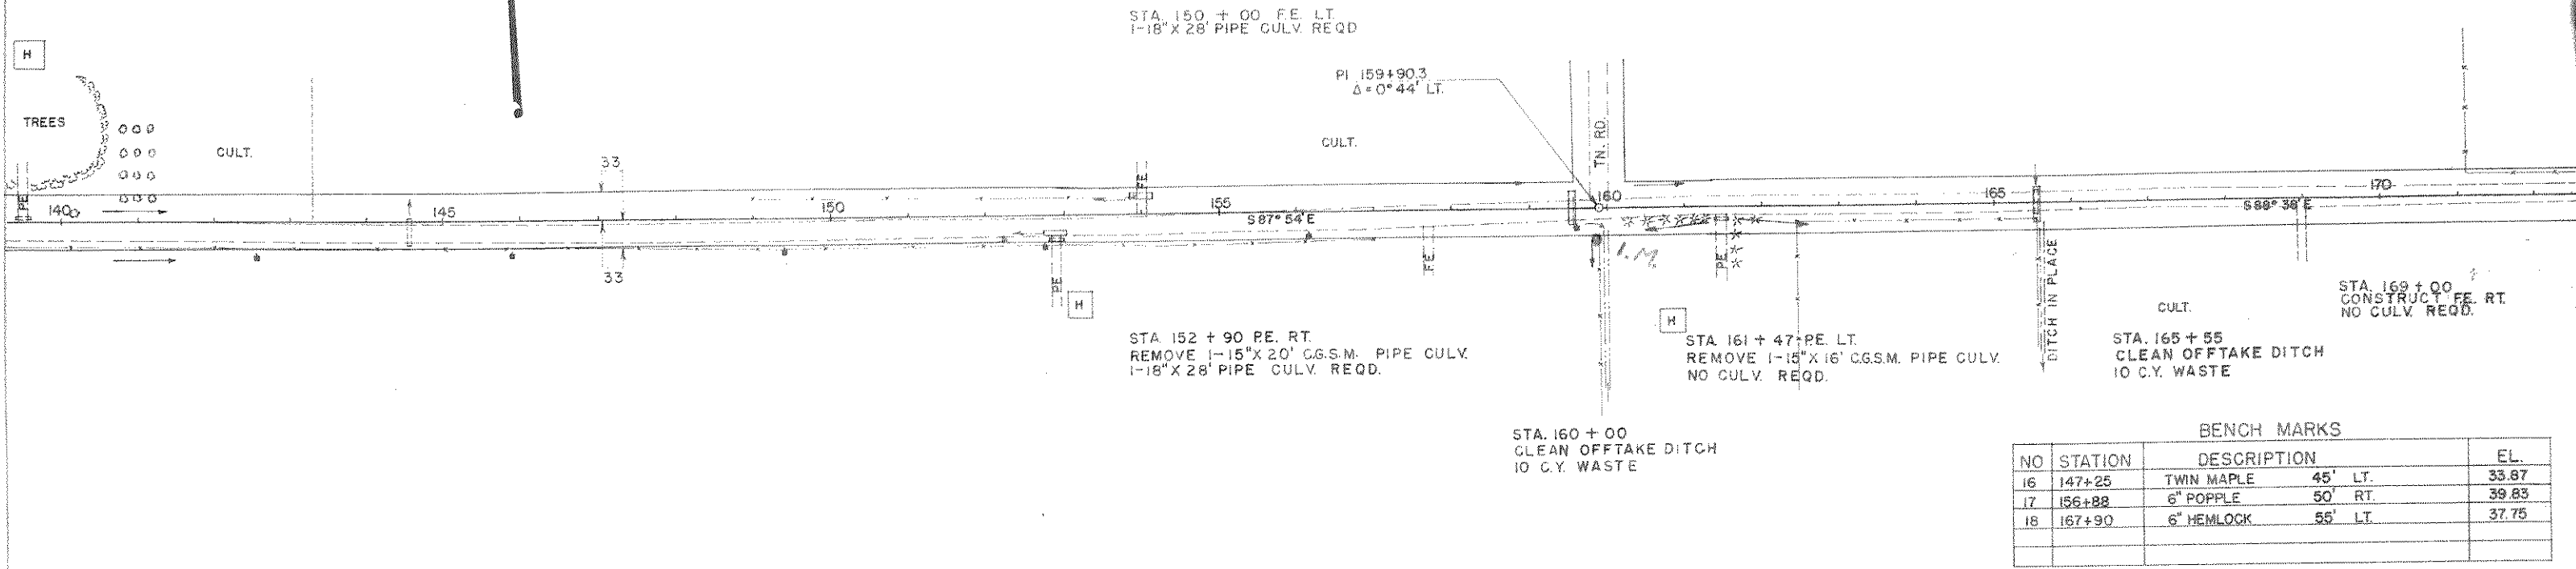


BENCH MARKS

NO	STATION	DESCRIPTION	EL.
16	147+25	TWIN MAPLE 45' LT.	35.87
17	156+88	6" POPLLE 50' RT.	39.83
18	167+90	6" HEMLOCK 55' LT.	37.75

PROFILE
 DRAWN BY: [Signature]
 CHECKED BY: [Signature]
 DATE: 5-2-53

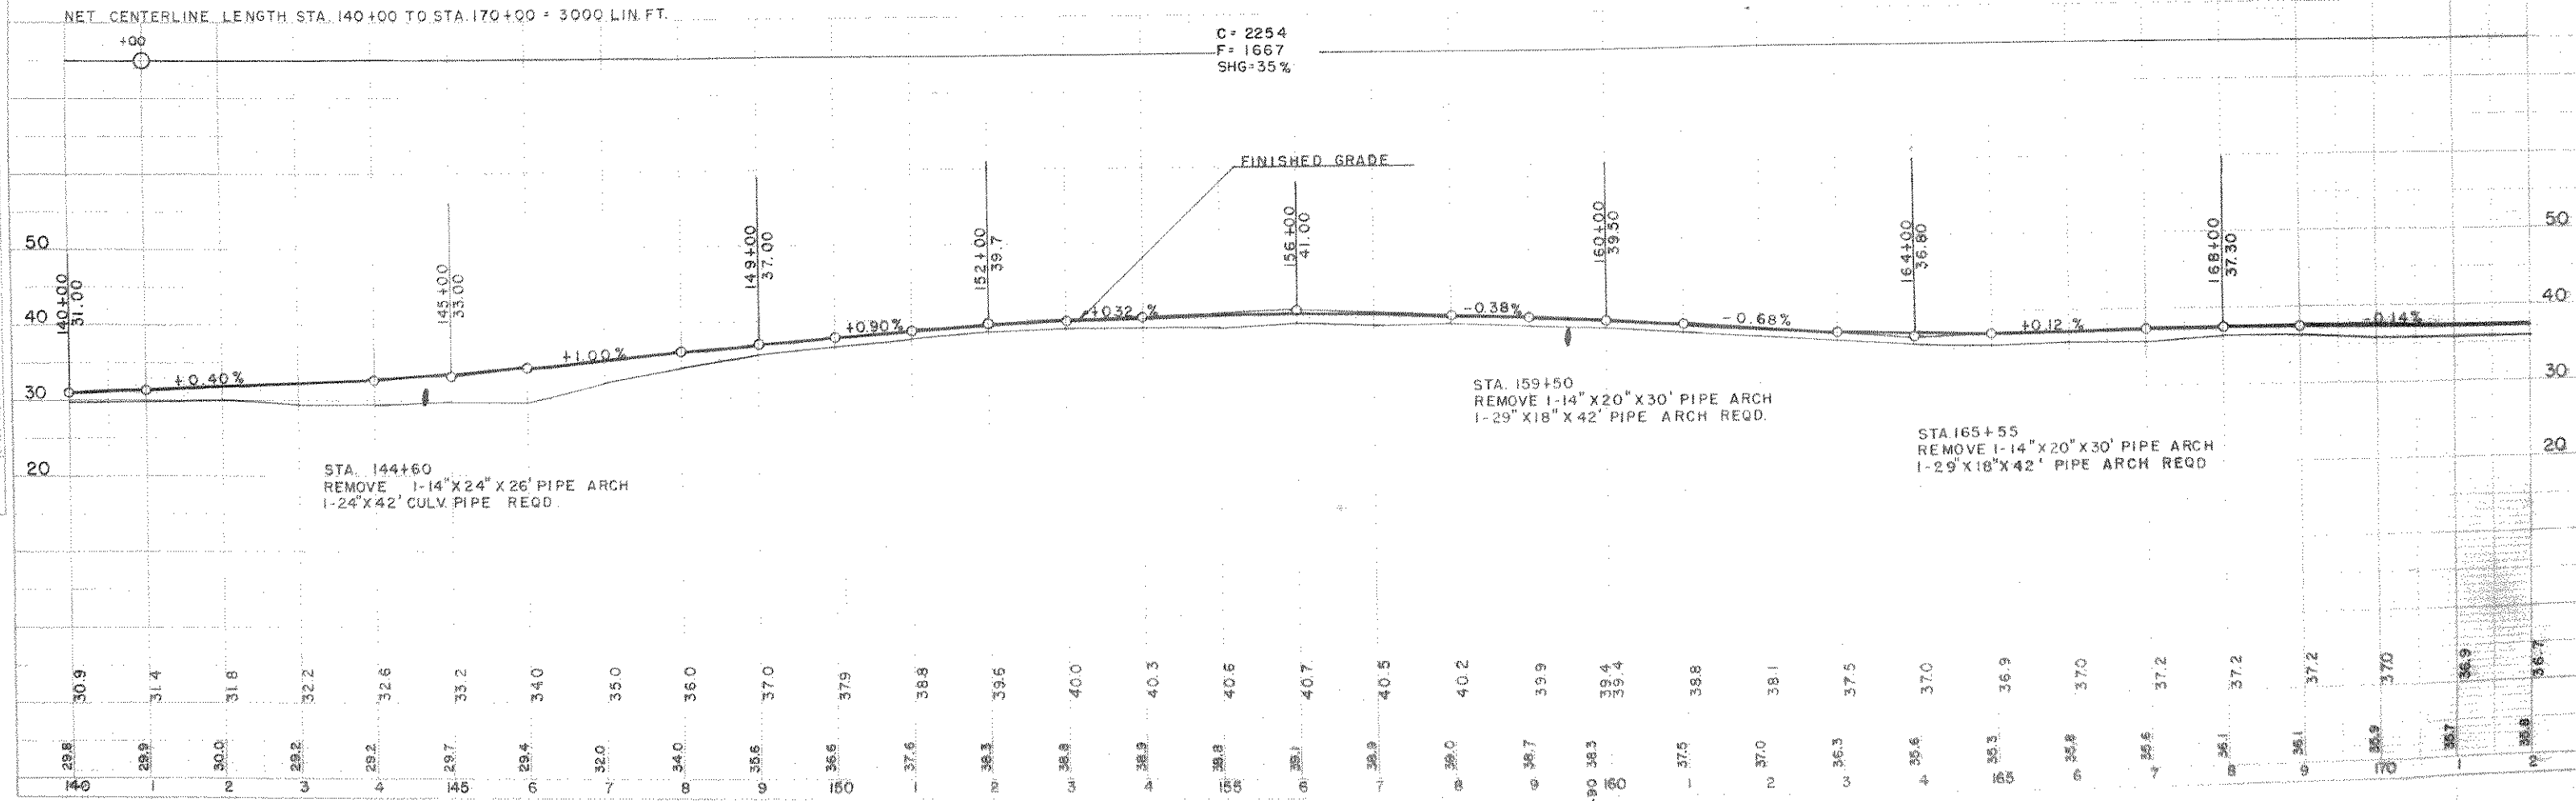

BPR DIVISION	PROJECT	SHEET NUMBER	TOTAL SHEETS
S N	S 0569(4)	9	36

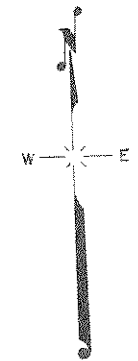


STA. 182+20 FE. LT.
1-24" X 26' PIPE CULV. REQD.

SHACK

STA. 194+00
CONSTRUCT FE. LT.
NO CULV. REQD.

STA. 200+45
CONSTRUCT FE. LT.
1-18" X 28' PIPE CULV. REQD.


PLAN
DRAWN BY: BB
CHECKED BY: DB
DATE: 5/23
SCALE: AS SHOWN
NOTE: BUSH CALCULATIONS CHECKED BY: BMB

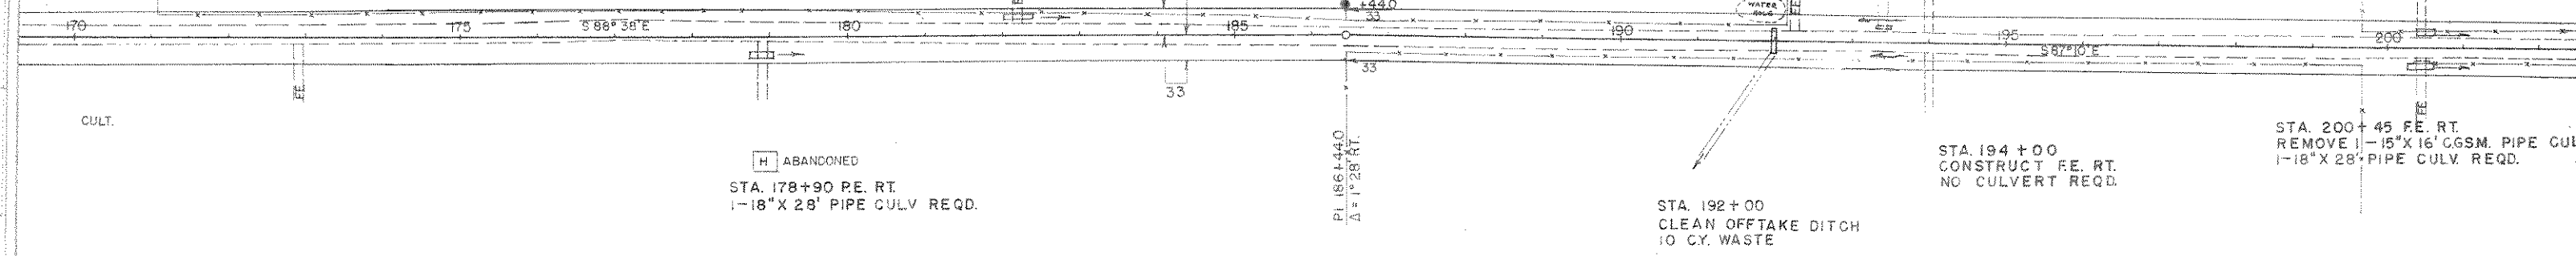

BENCH MARKS

NO	STATION	DESCRIPTION	EL.
19	178+10	DOUBLE 12" OAK 65' RT.	35.77
20	186+40	DOUBLE ELM 65' RT.	18.98
21	195+85	24" PINE STUMP 60' RT.	14.38

NET CENTERLINE LENGTH STA. 170+00 TO STA. 200+00 = 3000 LIN. FT.

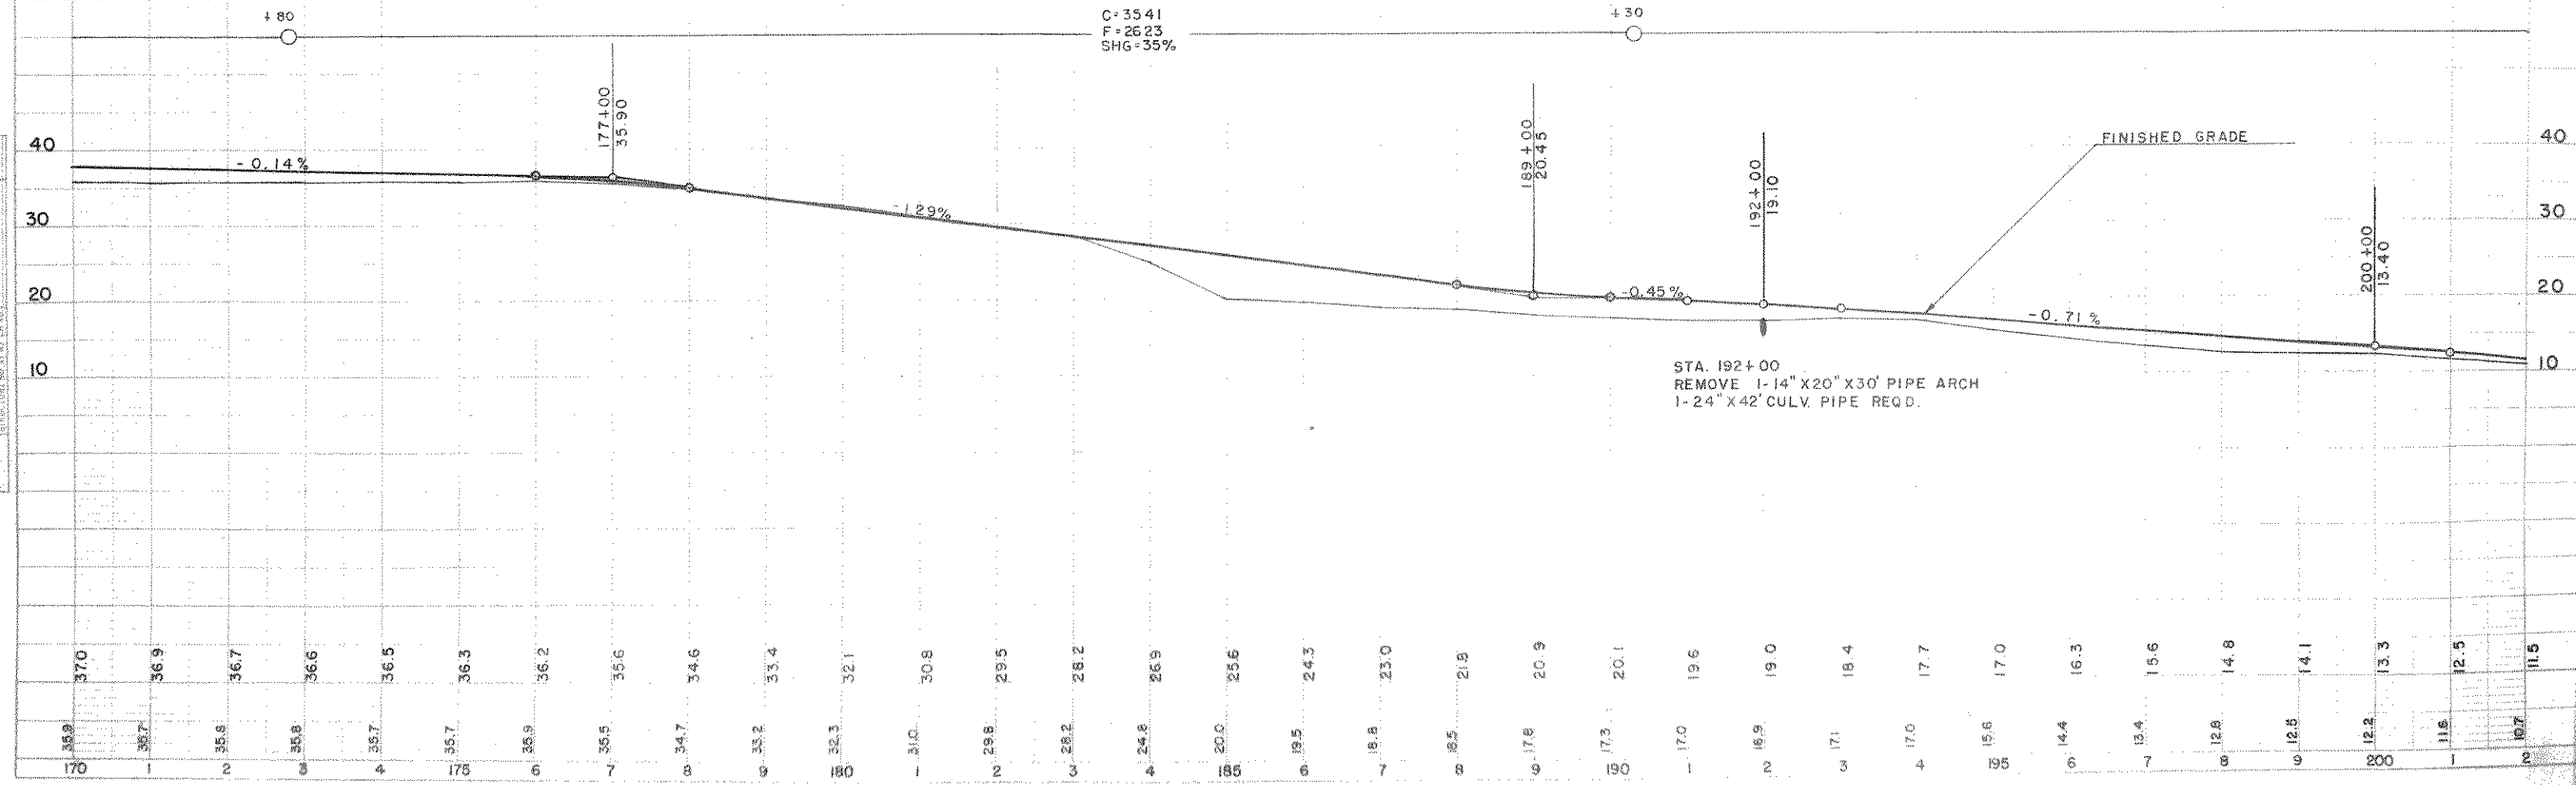



PROFILE
DRAWN BY: BB
CHECKED BY: DB
DATE: 5/23
SCALE: AS SHOWN
NOTE: BUSH CALCULATIONS CHECKED BY: BMB

STA. 192+00
REMOVE 1-14" X 20" X 30' PIPE ARCH
1-24" X 42' CULV. PIPE REQD.

BPR DIVISION	PROJECT	SHEET NUMBER	TOTAL SHEETS
S N	S 0569(4)	10	36

PLAN	DATE	BY	CHECKED
05/22	05/22	DD	DD
NOTE: ALL DIMENSIONS ARE IN FEET UNLESS OTHERWISE SPECIFIED.			

PROFILE	DATE	BY	CHECKED
05/22	05/22	DD	DD
NOTE: ALL DIMENSIONS ARE IN FEET UNLESS OTHERWISE SPECIFIED.			

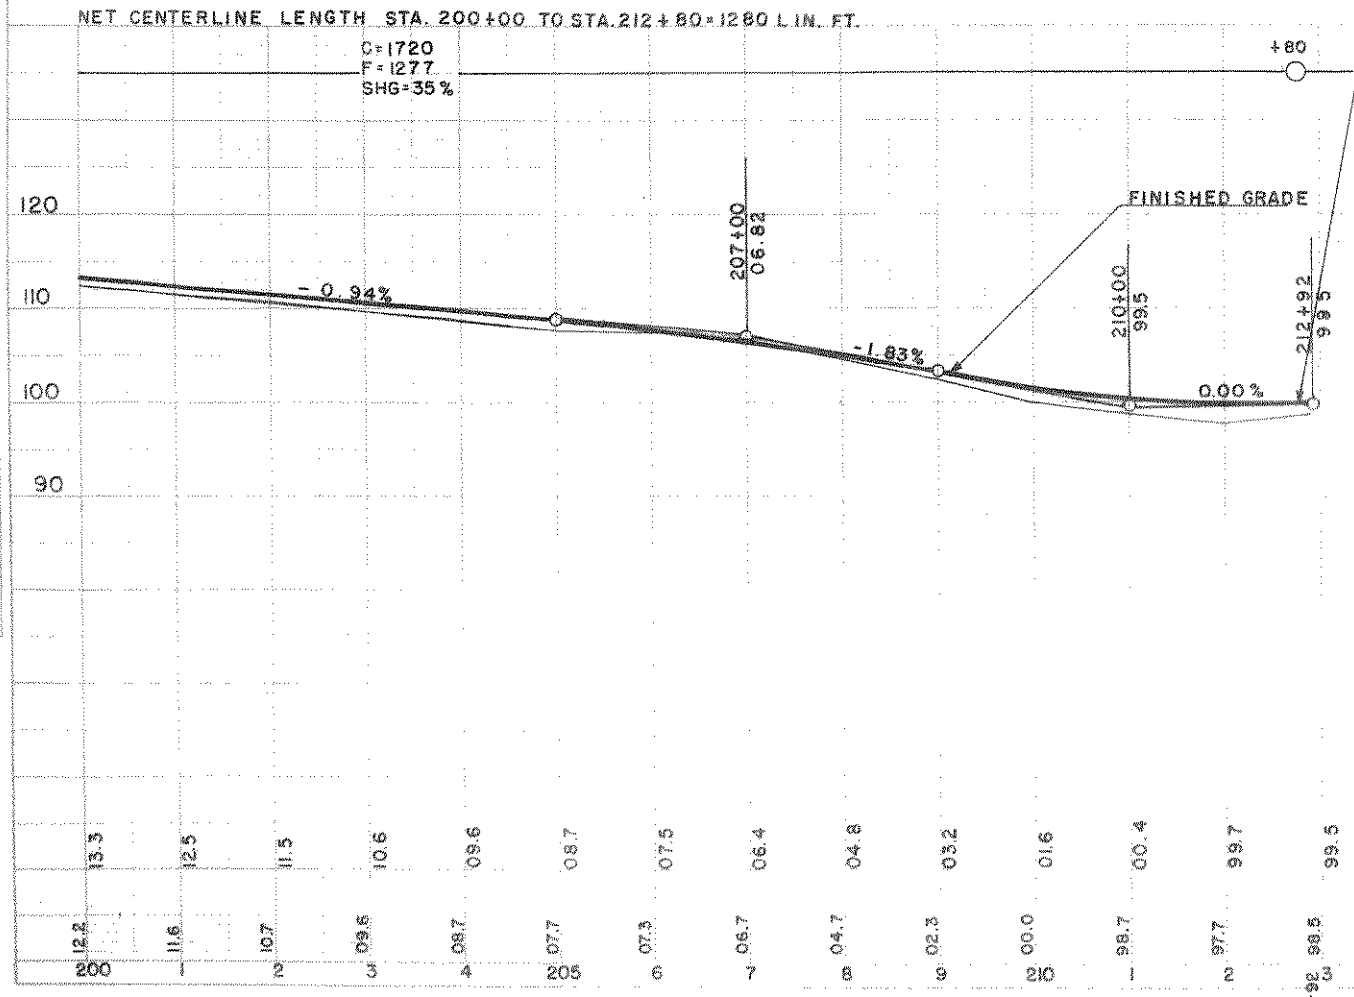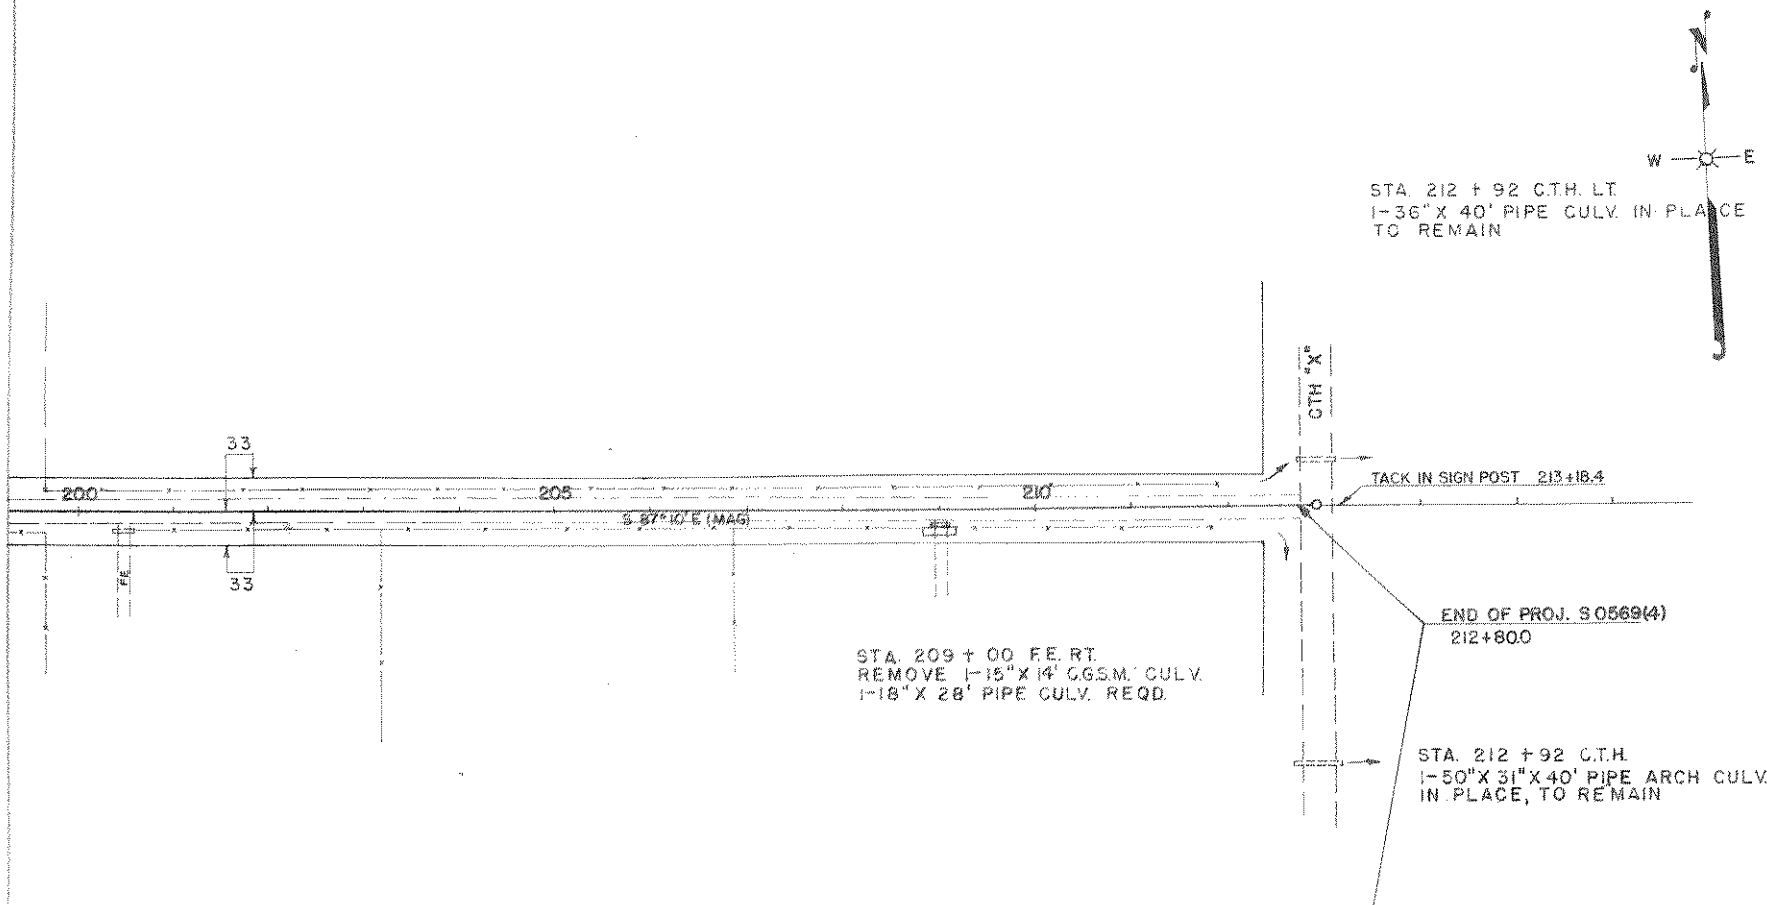

BENCH MARKS

NO	STATION	DESCRIPTION	EL.
22	206+35	30" PINE STUMP 120' RT.	107.98
23	213+20	T. POLE NO. 3108-35WI 55' RT.	96.33