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STATE OF WISCONSIN
STATE HIGHWAY COMMISSION OF WISCONSIN

PLAN AND PROFILE OF PROPOSED
WEST MAIN STREET, CITY OF MERRILL
S.T.H. 64
LINCOLN COUNTY
PROJECT T 013(4)

PLAN 1 IN. = 20 FT.
PROFILE HOR. 1 IN. = 20 FT. VERT. 1 IN. = 10 FT.
CROSS SECTIONS HOR. 1 IN. = 5 FT. VERT. 1 IN. = 5 FT.



BEGINNING OF PROJ. T013(4)
STA. 15+07.0
18' E. OF THE INTERSECTION OF STATE ST.
& W. MAIN ST.

END OF PROJ. T013(4)
STA. 27+65.0
W. ABUTMENT OF THE PRAIRIE
RIVER BRIDGE.

CONVENTIONAL SIGNS

- STATE LINE
- COUNTY LINE
- TOWNSHIP OR RANGE LINE
- SECTION LINE
- NEW RIGHT OF WAY LINE
- PRESENT RIGHT OF WAY LINE
- WIRE FENCE WOVEN
- BARBED
- LOT LINE
- CORPORATE OR CITY LIMITS
- PROPERTY LINE
- TRAVELED WAY OR P.E.
- RAILROADS
- BASE OR SURVEY LINE

- CULVERTS IN PLACE
- CULVERTS REQUIRED
- DROP INLET
- POWER POLE
- TELEPHONE OR TELEGRAPH POLE
- RIGHT OF WAY MARKERS
- REFERENCE STAKE FOR HUBS ONLY
- MARSH
- HEDGE
- TREES
- GROUND ELEVATION
- DATUM LINE
- GRADE ELEVATION
- DATUM LINE
- LIGHT POLES
- WATER VALVES
- PARKING METERS

LAYOUT

SCALE 1" = 1000 FT.

TOTAL NET LENGTH OF CENTERLINE = 0.238 MI.

COUNTY AND HIGHWAY	ROUTE AND SECTION	CLASS AND AGREEMENT		S.P.A. REGION DIVISION	SHEET NUMBER	TOTAL SHEETS
		STATE	FEDERAL			
35.2	13.0	22.4		4 WIS.	1	14




STATE HIGHWAY
COMMISSION OF WISCONSIN
MADISON, WIS.

SURVEYOR: M. HESS
DIVISION CHIEF: E. R. D.
DISTRICT CHECKER: C. H. M.

DATE: 6/2/60
RECOMMENDED FOR APPROVAL: [Signature]
DATE: 6/9/60
APPROVED: [Signature]
DATE: 6/9/60

DEPARTMENT OF COMMERCE
BUREAU OF PUBLIC ROADS

T 013(4)

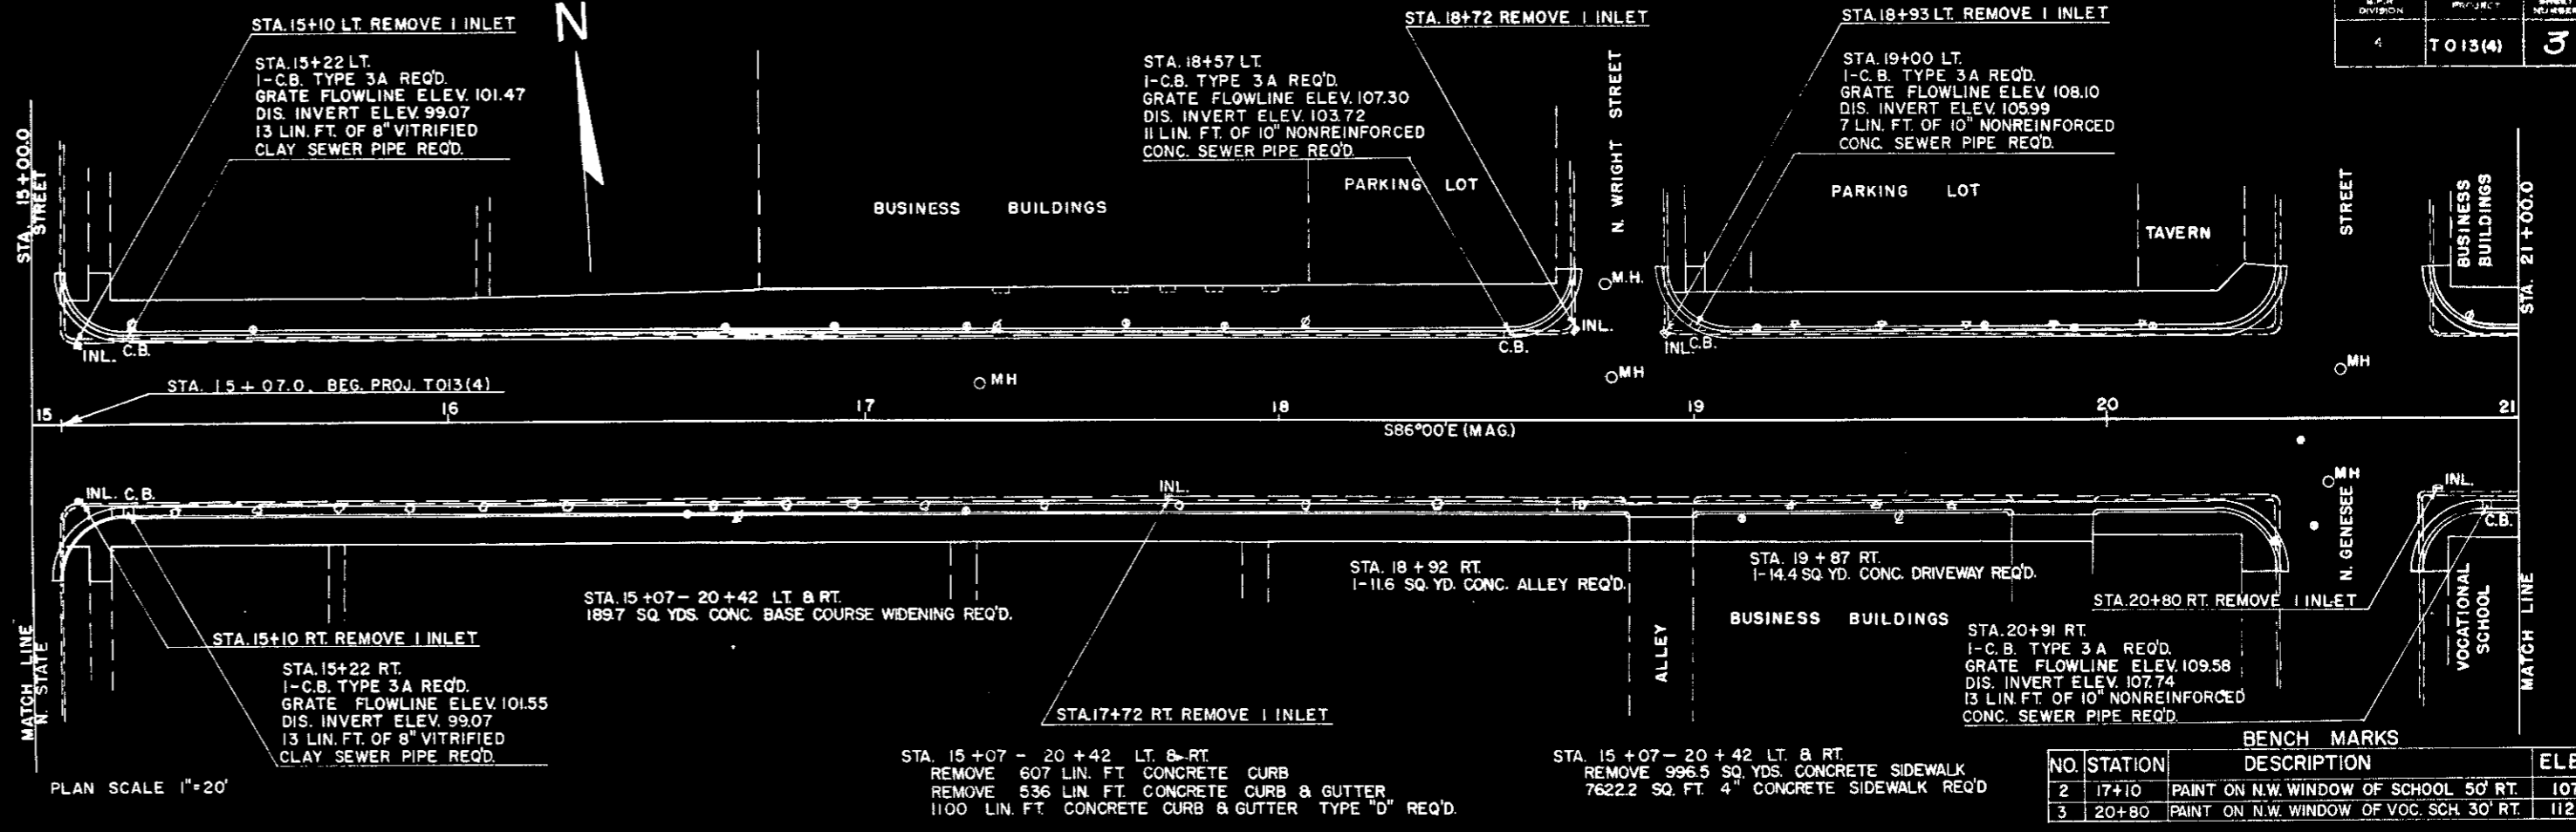


PLAN SCALE 1"=20'


BENCH MARKS			
NO	STATION	DESCRIPTION	ELEV.
2	17+10	PAINT ON N.W. WINDOW OF SCHOOL 50' RT.	107.55
3	20+80	PAINT ON N.W. WINDOW OF VOC. SCH. 30' RT.	112.47

NET CENTERLINE LENGTH STA. 15+00.0 - STA. 21+00.0 = 6000 LIN. FT.

PROFILE SCALE VERT. 1"=10'
HORIZ. 1"=20'

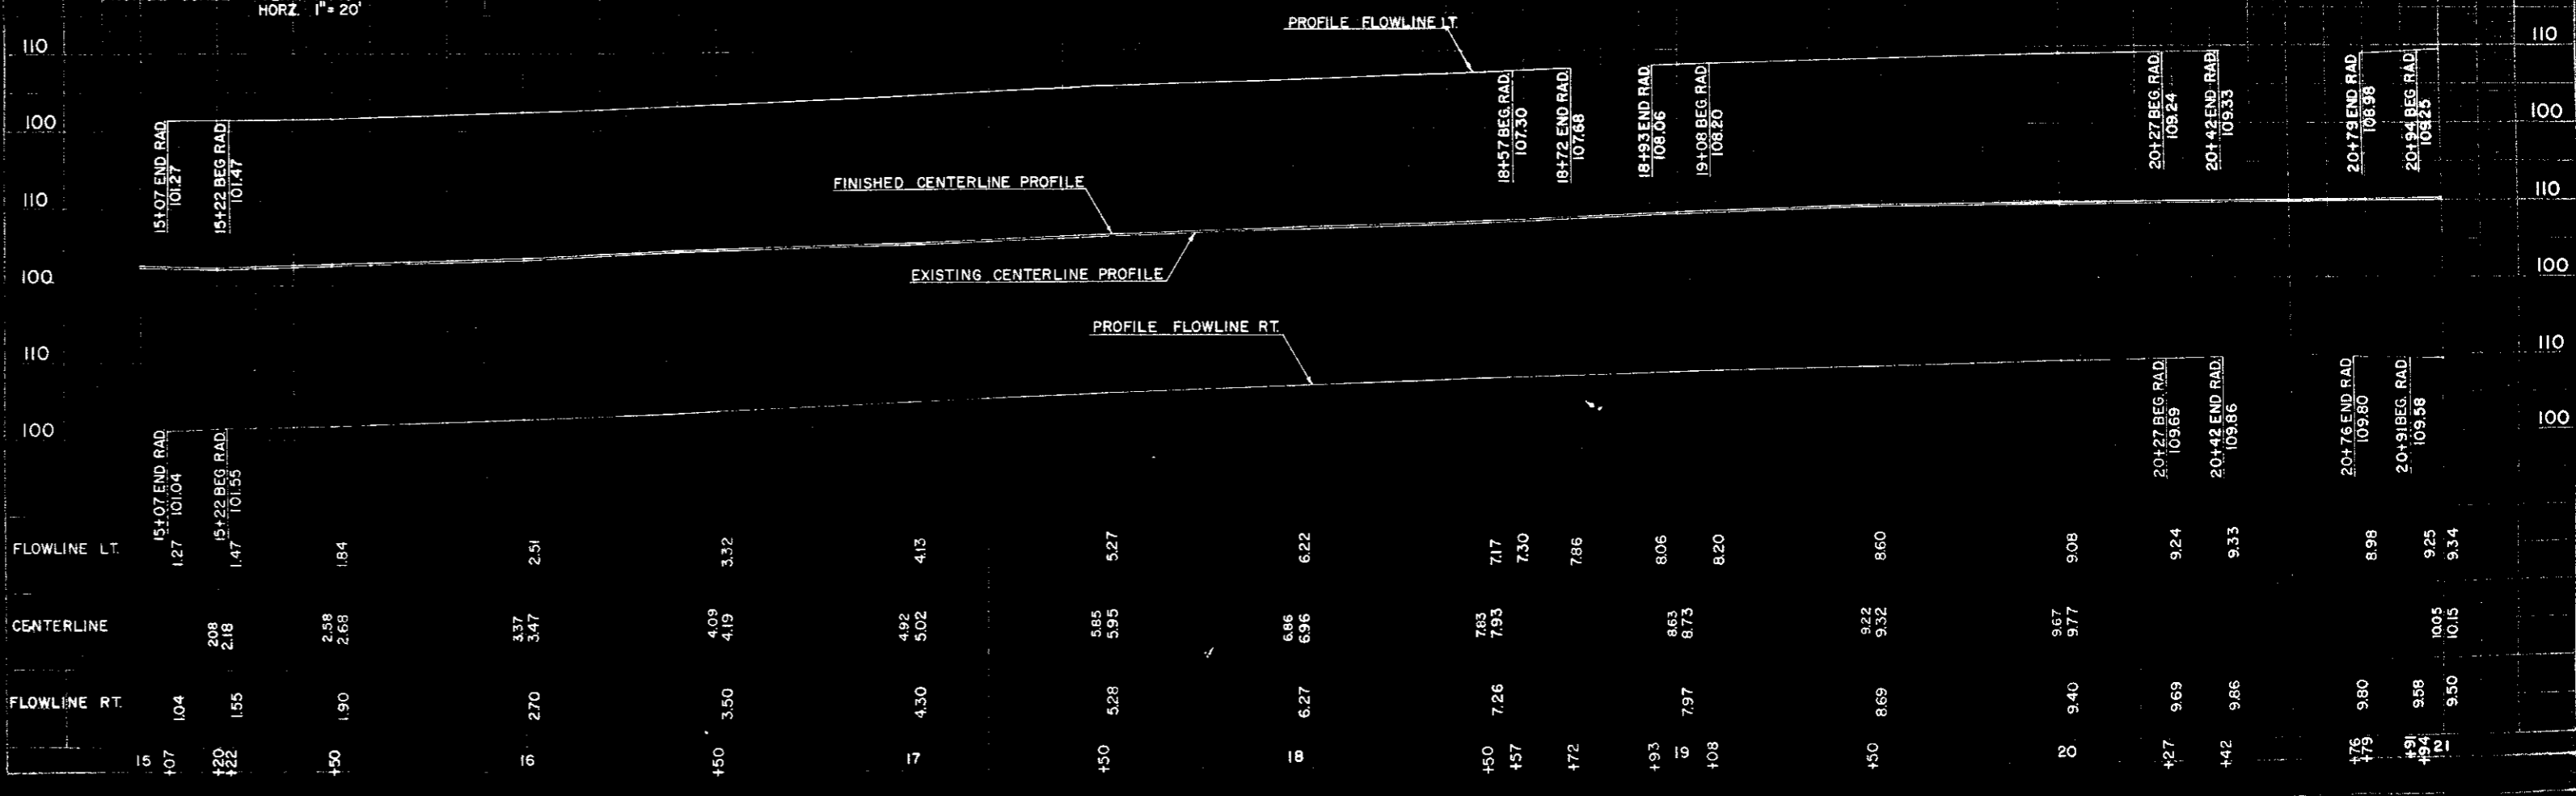


STATION	FLOWLINE LT.	CENTERLINE	FLOWLINE RT.
15+07	1.27	2.08	1.04
15+22	1.47	2.18	1.55
15+50	1.84	2.58	1.90
16+00	2.51	3.37	2.70
16+50	3.32	4.09	3.50
17+00	4.13	4.92	4.30
17+50	5.27	5.85	5.28
18+00	6.22	6.86	6.27
18+50	7.17	7.83	7.26
18+57	7.30	7.93	7.30
18+72	7.86	8.63	7.97
18+93	8.06	8.73	8.20
19+00	8.20	8.89	8.40
19+50	8.60	9.22	8.69
20+00	9.08	9.67	9.40
20+27	9.24	9.77	9.69
20+42	9.33	9.84	9.86
20+79	8.98	9.58	9.80
20+94	9.25	10.05	9.58
21+00	9.34	10.15	9.50

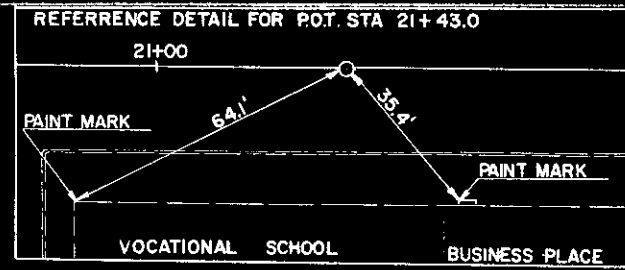

STA 23+39 LT.
1-C.B. TYPE 3A REQ'D.
GRATE FLOWLINE ELEV. 107.62
DIS. INVERT ELEV. 104.51
10 LIN. FT. OF 10" NONREINFORCED
CONC. SEWER PIPE REQ'D.

STA 23+50
REMOVE 1
INLET

STA. 23 + 93 - 27 + 00 LT & RT
REMOVE 450.6 SQ. YDS. CONCRETE SIDEWALK
2805.8 SQ. FT. 4" CONCRETE SIDEWALK REQ'D.

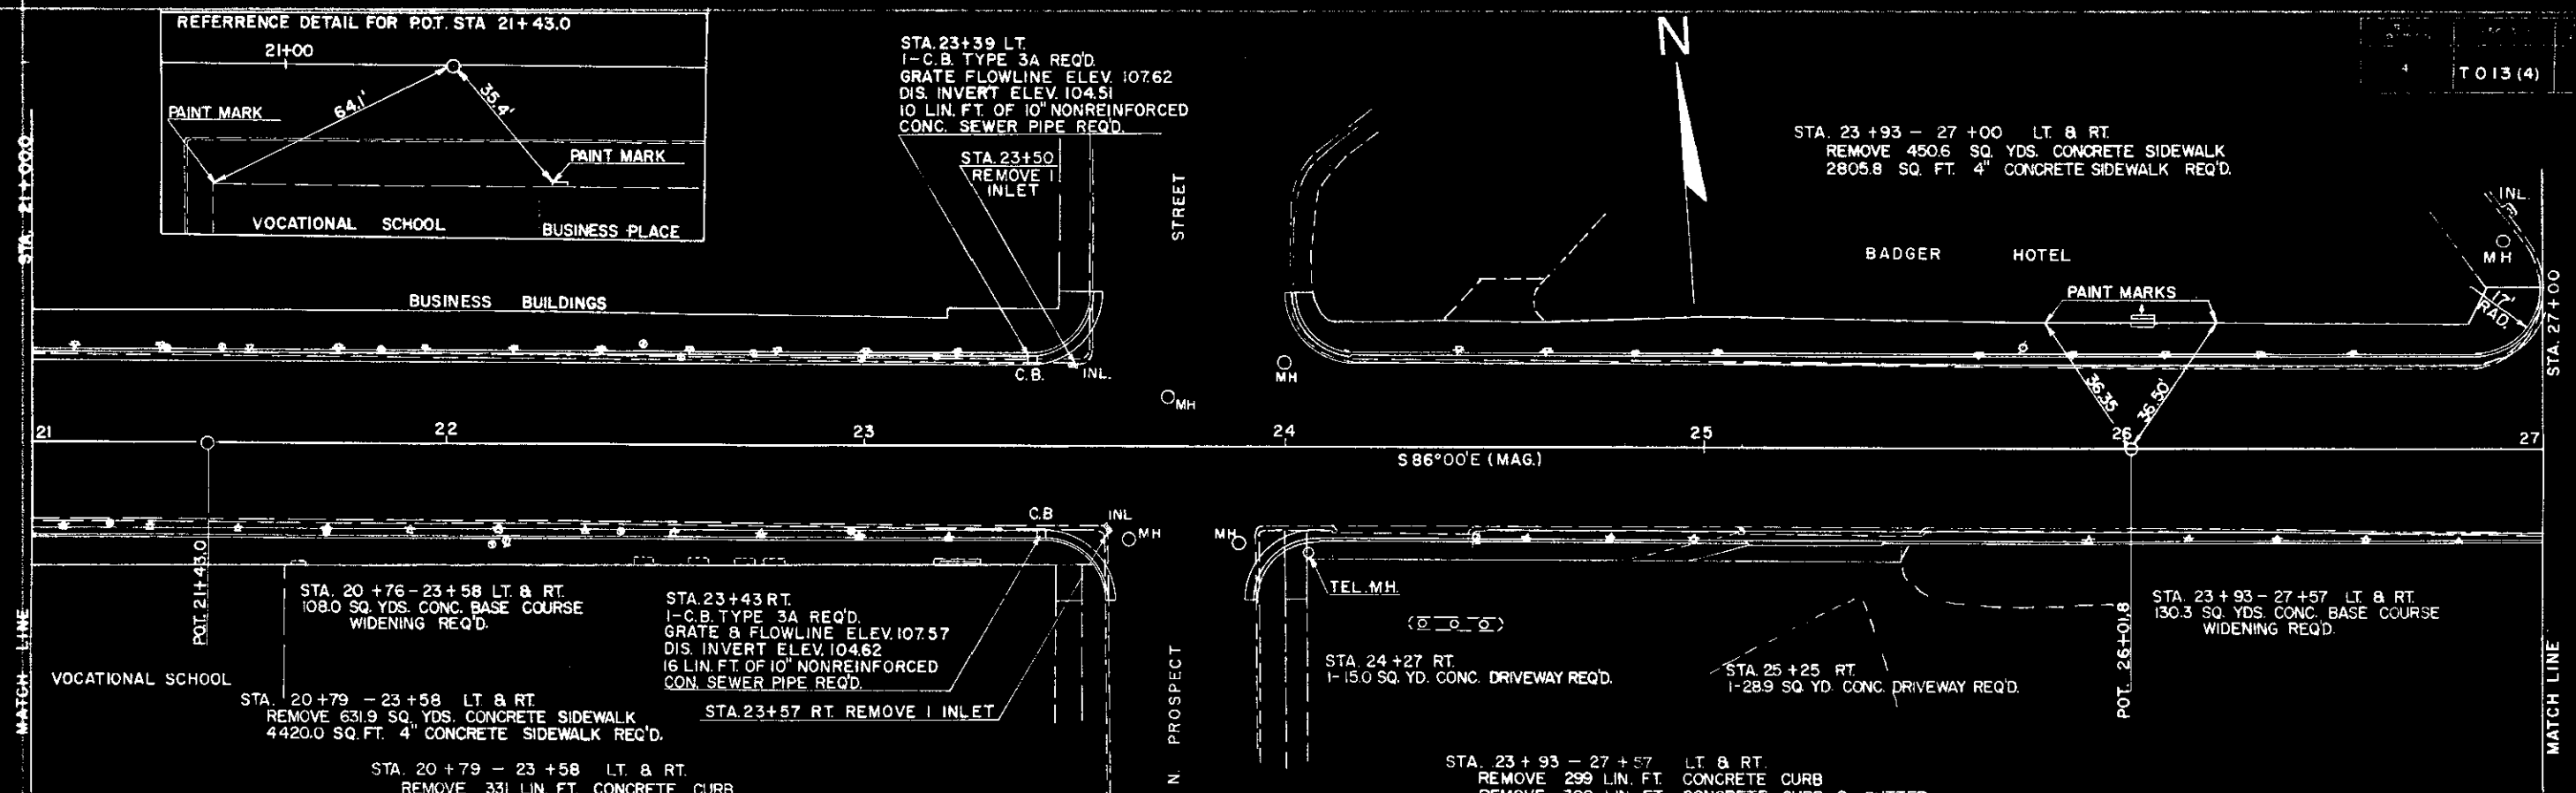

STA. 20 + 76 - 23 + 58 LT. & RT.
108.0 SQ. YDS. CONC. BASE COURSE
WIDENING REQ'D.

STA. 23 + 43 RT.
1-C.B. TYPE 3A REQ'D.
GRATE & FLOWLINE ELEV. 107.57
DIS. INVERT ELEV. 104.62
16 LIN. FT. OF 10" NONREINFORCED
CONC. SEWER PIPE REQ'D.

STA. 20 + 79 - 23 + 58 LT. & RT.
REMOVE 631.9 SQ. YDS. CONCRETE SIDEWALK
4420.0 SQ. FT. 4" CONCRETE SIDEWALK REQ'D.

STA. 23 + 57 RT. REMOVE 1 INLET

STA. 20 + 79 - 23 + 58 LT. & RT.
REMOVE 331 LIN. FT. CONCRETE CURB
REMOVE 292 LIN. FT. CONCRETE CURB & GUTTER
591 LIN. FT. CONCRETE CURB & GUTTER TYPE "D" REQ'D.

STA. 24 + 27 RT.
1-15.0 SQ. YD. CONC. DRIVEWAY REQ'D.

STA. 25 + 25 RT.
1-289 SQ. YD. CONC. DRIVEWAY REQ'D.

STA. 23 + 93 - 27 + 57 LT. & RT.
130.3 SQ. YDS. CONC. BASE COURSE
WIDENING REQ'D.


STA. 23 + 93 - 27 + 57 LT. & RT.
REMOVE 299 LIN. FT. CONCRETE CURB
REMOVE 399 LIN. FT. CONCRETE CURB & GUTTER
689 LIN. FT. CONCRETE CURB & GUTTER TYPE "D" REQ'D.

PLAN SCALE 1"=20'

NET CENTERLINE LENGTH STA 21+00.0 - STA. 27+00.0 = 600.0 LIN. FT.



PROFILE SCALE VERT. 1"=10'
HORZ. 1"=20'

NO.	STATION	DESCRIPTION	ELEV.
4	27+70	PAINT ON NW. WINGWALL 30' LT.	100.00

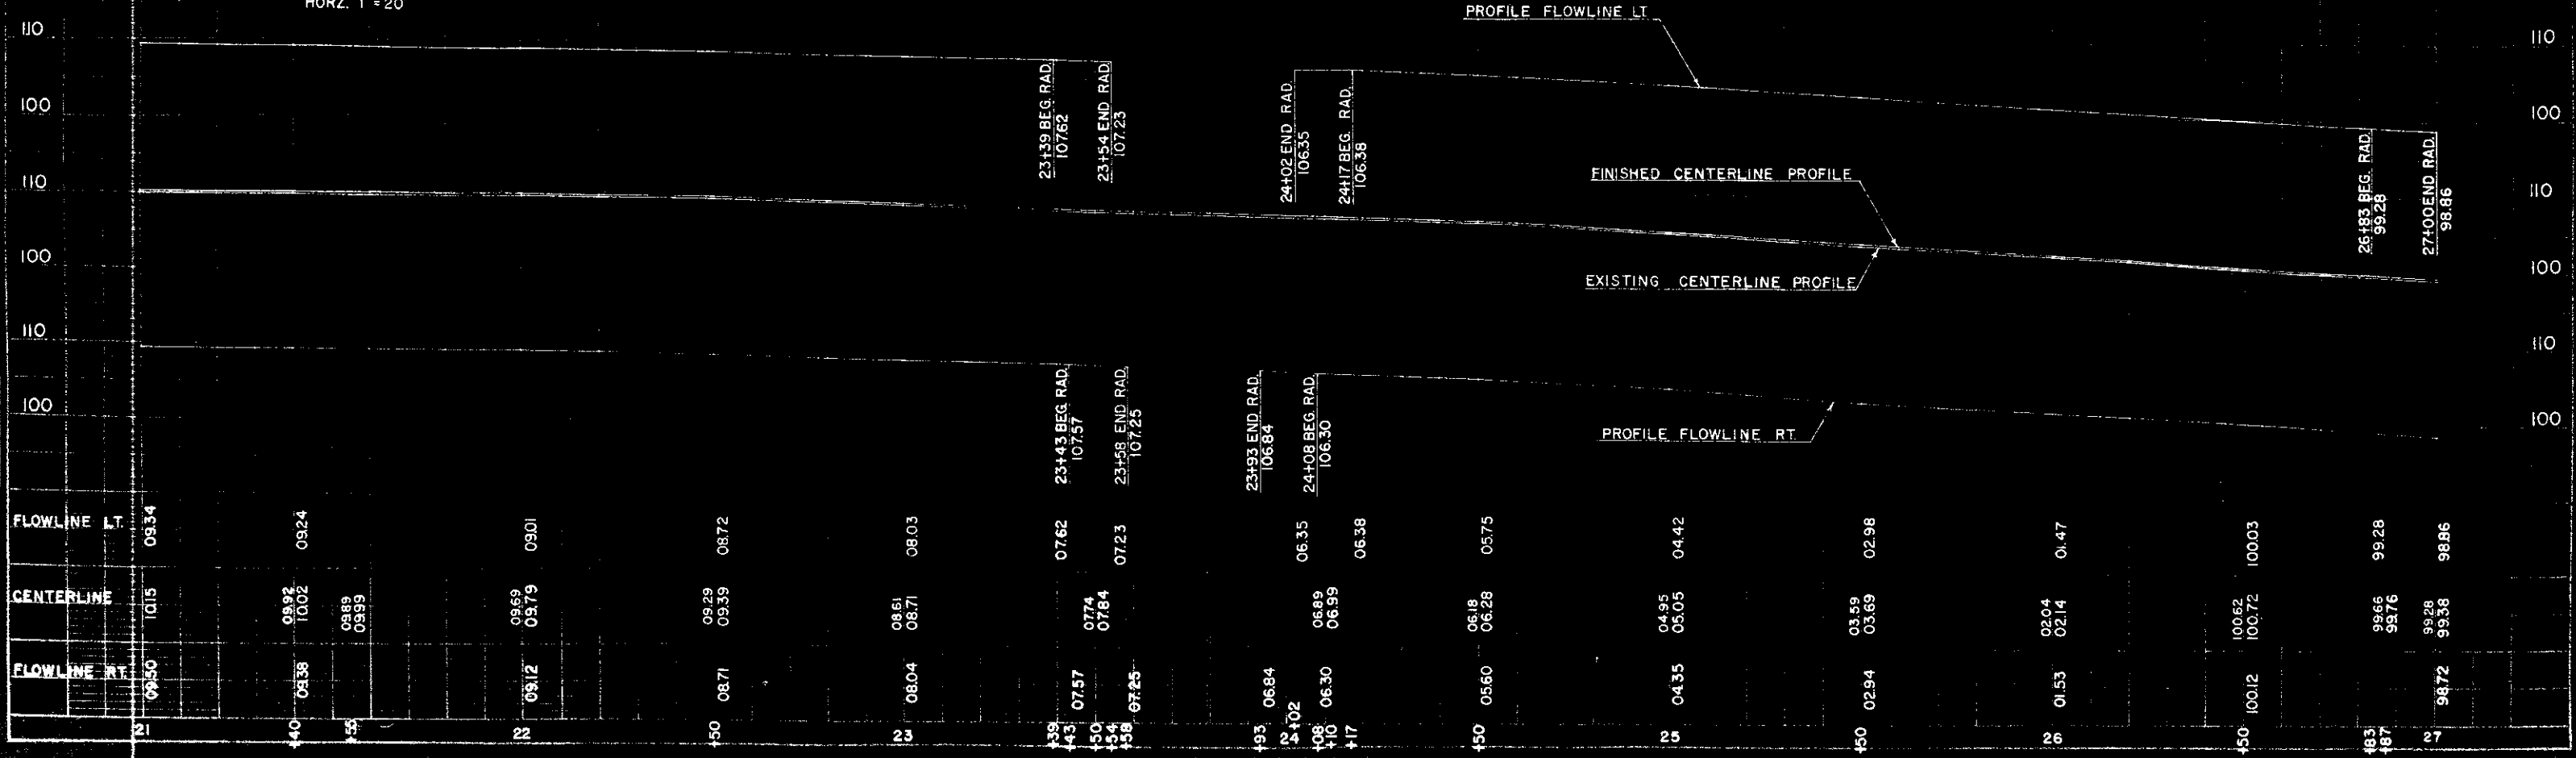

STATION	FLOWLINE LT.	CENTERLINE	FLOWLINE RT.
21	09.34	10.15	09.50
40	09.24	09.92	09.38
45		09.89	
		09.99	
22	09.01	09.69	09.12
		09.79	
50	08.72	09.29	08.71
		09.39	
23	08.03	08.61	08.04
		08.71	
39	07.62	07.74	07.57
43		07.84	
50	07.23		
54			
58			
93	06.35	06.84	06.84
95		06.30	
102			
108	06.35	06.89	06.30
110		06.99	
17	06.38		
50	05.75	06.18	05.60
		06.28	
25	04.42	04.95	04.35
		05.05	
50	02.98	03.59	02.94
		03.69	
26	01.47	02.04	01.53
		02.14	
50	100.03	100.62	100.12
		100.72	
83	99.28	98.65	98.72
87		99.76	
27	98.86	99.28	98.86
		99.38	

N

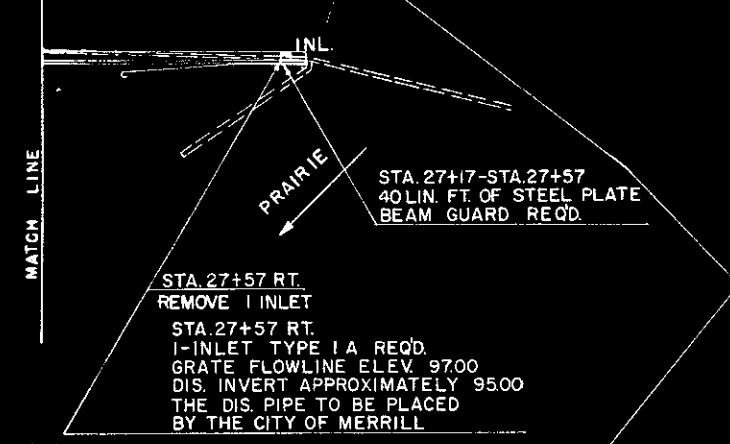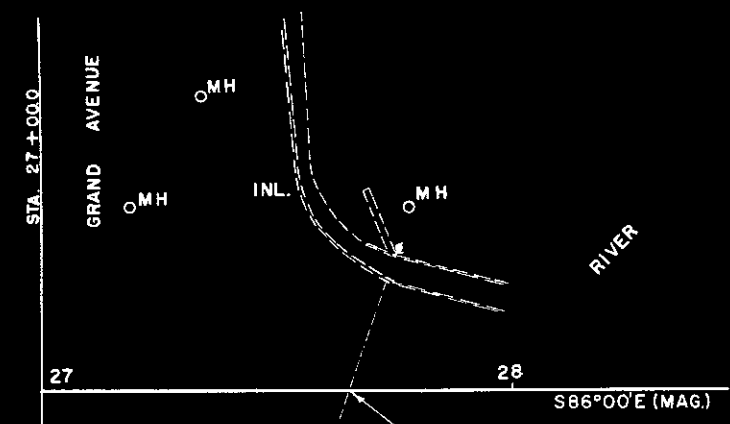


END PROJ. T013(4)
STA. 27+65.0

PLAN SCALE 1" = 20'

NET CENTERLINE LENGTH STA. 27+00-27+65.0 = 65.0 LIN. FT.

PROFILE SCALE VERT. 1" = 10'
HORZ. 1" = 20'

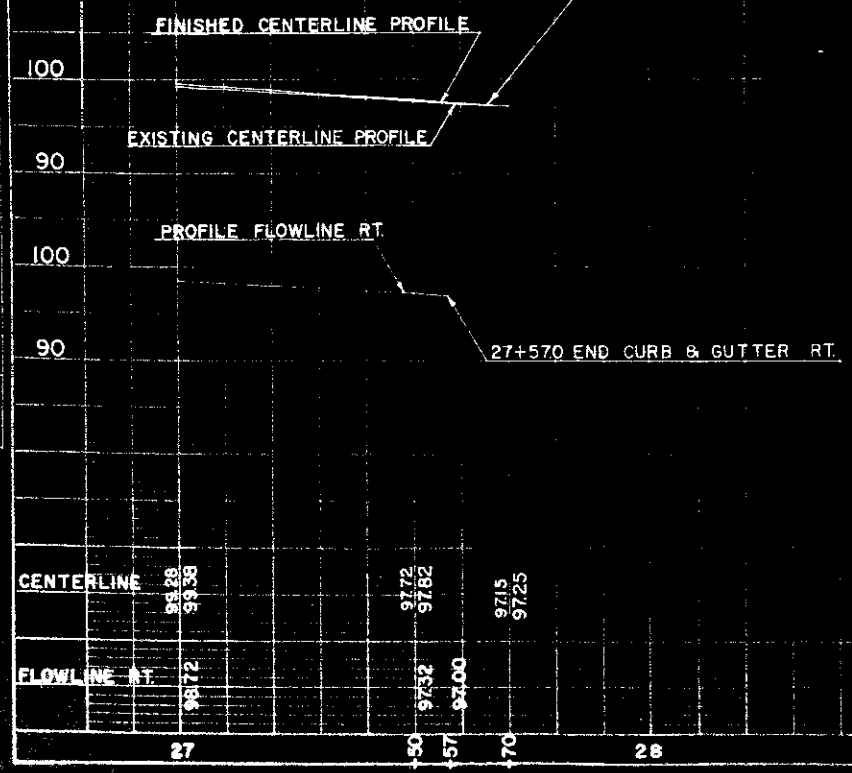

DATE 3-80
BY M. HESS
M.H.E.R.D.
SURVEYED, PLOTTED, AND CHECKED BY M.H.E.R.D.
NO. 1018M

DATE 3-80
BY M.H.E.R.D.
M.H.E.R.D.
SURVEYED, PLOTTED, AND CHECKED BY M.H.E.R.D.
NO. 1018M